

# Application for Public Hearing SPECIAL USE PERMITS

YOU MUST PROVIDE THE FOLLOWING INFORMATION: IF ADDITIONAL SPACE IS NEEDED, ATTACH EXTRA PAGES TO THE PETITION.

Name of Business (If applicable):						
Address/Location of Property in Question: 715 LAKE STREET						
Property Identification Number(s)(PIN):16-07-224-004-0000						
Name of Property Owner(s):INFRAUS WIRELESS I, LLC, ATTORNEY-IN FACT FOR OP MEDICAL ARTS HOLDING, LLC						
Address of Property Owner(s):						
E-Mail of Property Owner(s):Phone:Phone:						
If Land Trust, name(s) of all beneficial owners: (A Certificate of Trust must be filed.)						
Name of Applicant(s):DISH WIRELESS						
Applicant's Address: 5701 SOUTH SANTA FE DRIVE, LITTLETON, CO 80120						
Applicant's Phone Number:E-Mail						
Other: Project Contact: (if Different than Applicant)ARIEL STOUDER - FULLERTON						
Contact's Address: 1100 WOODFIELD ROAD #500, SCHAUMBURG, IL 60173						
Contact's Phone Number: <b>574-849-8420</b> E-Mail <b>ASTOUDER@FULLERTON-US.COM</b> Other:						
Property Interest of Applicant:OwnerLegal RepresentativeContract Purchaser _ <b>x</b> _Other (If Other - Describe): <b>TENANT</b>						
Existing Zoning:Describe Proposal: TELECOMMUNICATIONS EQUIPMENT INSTALLATION FOR DISH WIRELESS ON ROOFTOP. INSTALL (3) ANTENNAS,						
(6) RADIOS, ANTENNA MOUNTS, AND CABLING. ON AN EXISTING STEEL PLATFORM INSTALL AN EQUIPMENT CABINET.						

Adjacent:       Z         To the North:          To the South:          To the East:          To the West:	DT-2 DT-2 DT-2	Land Uses <u>COMMERCIAL</u> RESIDENTIAL		
To the South: To the East:	DT-2 DT-2			
To the East:	DT-2	RESIDENTIAL		
To the East: To the West:	DT-2			
To the West:		MIXED USE		
	DI-2			
How the property	in question is current	y improved?		
			OTHER:	
Describe I	mprovement: <b>INSTAL</b>	LATION OF WIRELESS	ELECOMMUNICATION ANT	ENNA EQUIPMENT
		•	rdinance?YesX	
If Yes, hov	v?			
			ermit?YesNo	
It Yes, plea	ase provide relevant Or	ainance No.'s		
le the subject pror	perty located within ar	ny Historic District?	Yes X No	
	-	□ Ridgeland/Oak Park		
II Tes. L				
From what Section	n(s) of the Zoning Ord	inance are you requesti	ng approval / relief?	
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Article:	8	Section:	8.3	
Article:		Section:		
Article:		Section:		

I (we) certify that all the above statements and the statements contained in any papers or plans submitted herewith are true to the best of my (our) knowledge and belief.

I (we) consent to the entry in or upon the premises described in this application by any authorized official of the Village of Oak Park for the purpose of securing information, posting, maintaining and removing such notices as may be required by law.

### DISH WIRELESS CARE OF FULLERTON

(Printed Name) Applicant

Ariel Stouder

(Signature) Applicant ARIEL STOUDER O.B.O. DISH WIRELESS

**5/6/2024** Date

INFRAUS WIRELESS I, LLC, ATTORNEY-IN FACT FOR OP MEDICAL ARTS HOLDING, LLC (Printed Name) Owner

Cha

5/6/2024


Date

(Signature) Owner Caitlin Garzoli

# Owner's Signature must be notarized

SUBSCRIBED AND SWORN TO BEFORE ME THIS

DAY OF MAY , 2024

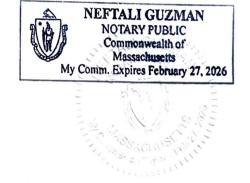

Updated August 2021

Petition for Public Hearing Page 3 of 3 DISH Wireless Section 6409(a) Eligible Facilities Request Cover Letter

April 25, 2024

## VIA EMAIL

Village of Oak Park Development Services ATTN: Michael Bruce 123 Madison Street Oak Park, IL 60302

## RE: CHCHI00890C / 715 LAKE STREET Eligible Facilities Request

To Whom It May Concern:

On behalf of DISH Wireless L.L.C. ("DISH Wireless"), we are submitting an Eligible Facilities Request ("EFR") to modify an existing support structure pursuant to Section 6409(a) of the Middle-Class Tax Relief and Job Creation Act of 2012 ("Spectrum Act") and the rules of the Federal Communications Commission ("FCC"). *See* Pub. Law No. 112-96, 126 Stat. 156 (2012); 47 C.F.R. §1.6100.

Specifically, as it moves to deploy a new broadband network, DISH Wireless is proposing to install new telecommunications equipment on a rooftop site. The proposal includes installing (3) antennas, (6) radios, antenna mounts, and cabling. On an existing steel platform an equipment cabinet will be installed. (the "Request"). This project will help support the connectivity needs of residents, businesses, and first responders. DISH Wireless looks forward to working cooperatively with you to advance these important efforts in your community.

This Request is governed by Section 6409(a) of Spectrum Act which, as you may know, provides that state and local governments "may not deny, and shall approve" any EFR to modify an existing wireless tower or base station that does not "substantially change the physical dimensions of such tower or base station." *See* Spectrum Act § 6409(a)(1), 126 Stat. at 232. Under Section 6409, such modifications include the collocation, removal, or replacement of transmission equipment. *See id.* § 6409(a)(2), 126 Stat. at 232-33. Under the FCC's rule implementing Section 6409(a), an existing base station is a structure that currently houses or supports an approved antenna, transceiver or other associated equipment "even if the structure was not built for the sole or primary purpose of providing such support." 47 C.F.R. § 1.6100(b)(1), (b)(5).

Similarly, the list of equipment that will be installed as part of this Request qualifies as "transmission equipment," which the FCC defines as "[e]quipment that facilitates transmission for any Commission-licensed or authorized wireless

communication service, including, but not limited to, radio transceivers, antennas, coaxial or fiber-optic cable." *See* 47 C.F.R. § 1.6100(b)(8).

The FCC has determined that a modification is not a substantial change, and therefore is an EFR that shall be approved under the Spectrum Act, as long as it does not fall within any of the following six criteria (47 C.F.R. § 1.6100(b)(7)):

- 1. For towers other than towers in the public rights-of-way, it increases the height of the tower by more than 10% or by the height of one additional antenna array with separation from the nearest existing antenna not to exceed twenty feet, whichever is greater; for other eligible support structures, it increases the height of the structure by more than 10% or more than ten feet, whichever is greater;
- 2. For towers other than towers in the public rights-of-way, it involves adding an appurtenance to the body of the tower that would protrude from the edge of the tower more than twenty feet, or more than the width of the tower structure at the level of the appurtenance, whichever is greater; for other eligible support structures, it involves adding an appurtenance to the body of the structure that would protrude from the edge of the structure by more than six feet;
- 3. For any eligible support structure, it involves installation of more than the standard number of new equipment cabinets for the technology involved, but not to exceed four cabinets; or, for towers in the public rights-of-way and base stations, it involves installation of any new equipment cabinets on the ground if there are no pre-existing ground cabinets associated with the structure, or else involves installation of ground cabinets that are more than 10% larger in height or overall volume than any other ground cabinets associated with the structure;
- 4. It entails any excavation or deployment outside the current site;
- 5. It would defeat the concealment elements of the eligible support structure; or
- 6. It does not comply with conditions associated with the siting approval of the construction or modification of the eligible support structure or base station equipment, provided however that this limitation does not apply to any modification that is non-compliant only in a manner that would not exceed the thresholds identified in criteria 1-4 above.

Pursuant to Section 1.6100(c) of the FCC's rules, which provides that jurisdictions may require documentation or information "only to the extent reasonably related to determining whether the request meets the requirements" of the FCC rule, DISH Wireless provides the following information to demonstrate that the proposed Request does not constitute a substantial change under the criteria above because it:

- 1. Does not involve an increase in height in excess of the limits in 47 C.F.R. § 1.6100(b)(7)(i).
- 2. **Details** Per the plan sets provided, the installation of the new antenna equipment will not cause an increase in the height of the building.
- 3. Does not involve an increase in width in excess of the limits in 47 C.F.R. § 1.6100(b)(7)(ii).

**Details:** Per the plan sets provided, the installation of the new antenna equipment will not involve an increase in width of the equipment from the building. The antennas will be installed on the walls of the rooftop.

4. Does not involve installation of new equipment cabinets in excess of the limits in 47 C.F.R. § 1.6100(b)(7)(iii).

**Details:** Per the plan sets provided, there will only be (1) equipment cabinet installed. Which is not more than the (4) equipment cabinet limit.

5. Does not involve any excavation or deployment outside the current site.

**Details:** Per the plan sets provided the proposed work does not involve any excavation or deployment outside the current site. The installation of all equipment will take place on the rooftop.

6. Would not defeat any concealment elements of the eligible support structure.

**Details:** Per the plan sets provided, there are no concealment elements located on the rooftop.

7. Complies with any prior conditions, except for any non-compliance due to exceeding the thresholds in criteria 1-4 above.

**Details:** There are not any prior conditions in place for the installation of new equipment on the rooftop.

Under the FCC's rule, the submission of this request for EFR approval initiates a 60-day shot clock to review and approve the application. *Id.* § 1.6100(c)(2). If that time passes without action, "the request shall be deemed granted." *Id.* § 1.6100(c)(4).

DISH Wireless is committed to working cooperatively with you to process this request in a timely and efficient manner. We look forward to developing a long-term collaborative working relationship with you.

Please do not hesitate to contact me if you have any questions or need any other information.

Respectfully submitted,

Rebecca B. Falcón

Rebecca Falcon Site Acquisition Project Manager II M: (312) 498-9556 rebecca.falcon@dish.com



May 1, 2024

Village of Oak Park ATTN: Michael Bruce Development Services 123 Madison Street Oak Park, IL 60302

Re: Narrative on the Installation and Operation of New DISH Wireless Network Equipment to the Existing Telecommunication Facilities Rooftop at 715 Lake Street, Oak Park, IL 60301 DISH Site CHCHI00890C

To Whom It May Concern,

Fullerton on behalf of DISH Wireless, would like to submit for review a Project Narrative for the proposed addition of Wireless Antennas and Support Equipment to the facilities located at 715 Lake Street. DISH Wireless is proposing to install their telecommunication equipment on the rooftop and within a leased space on the rooftop supporting equipment. Currently, there is (1) other carrier located on this rooftop. This has established the rooftop telecommunications facility as determined by Section 6409(a) of the Middle-Class Tax Relief and Job Creation Act of 2012 ("Spectrum Act") and the rules of the Federal Communications Commission ("FCC"). *See* Pub. Law No. 112-96, 126 Stat. 156 (2012); 47 C.F.R. §1.6100.

On the rooftop located at 715 Lake Street, DISH Wireless is proposing to install (3) antennas, (6) radios, and associated cabling on (3) antenna sectors to be located throughout the rooftop. Also proposed to be installed on the rooftop, DISH would install an equipment cabinet on an existing metal platform. The proposed addition of DISH Wireless's equipment will not cause an increase in the height of the building. As the equipment will be installed on the rooftop this would not cause an increase in the existing space.

DISH Wireless is a division of the company we all know to be the satellite television provider. In recent years, DISH has become one of the major wireless carriers. Wireless Communications have been designated Critical Infrastructure by the Federal Government and should be considered Essential Services in all Comprehensive Plans. As DISH Wireless is constructing this new network, every new facility in the network is essential to their seamless operation.

This facility, located at 715 Lake Street, was selected to extend DISH Wireless network to the Village of Oak Park. The proposed telecommunication antennas will not cause an increase in the existing height of the building. The tallest point on the building is a smokestack at 119'-6". There is also other carrier telecommunication equipment that is installed above the roofline.



DISH Wireless would install their telecommunication equipment on (3) separate antenna sectors throughout the rooftop for operation. The Alpha and Gamma Sector antennas and radios will be mounted to a penthouse wall at the 106'-6" centerline. The Beta Sector will be located on another penthouse wall at the 95'-6" centerline.

The proposed installation of the DISH Wireless antenna equipment will not cause a significant visual impact to the building or the surrounding area. This rooftop is an established telecommunications facility because of the presence of the other carrier. DISH Wireless is not proposing any significant modifications by installing their equipment.

If there are still any outstanding questions or concerns, please feel free to reach out using any of my contact information listed below in my signature. Addressing all concerns for this project is of utmost importance to myself, and DISH Wireless.


Best regards,

Ariel Stouder Senior Zoning and Permitting Specialist Fullerton, on behalf of DISH Wireless M: 574-849-8420 Email: <u>astouder@fullerton-us.com</u>



SITE ID: CHCHI00890C

SITE ADDRESS: 715 LAKE ST. OAK PARK, IL 60301

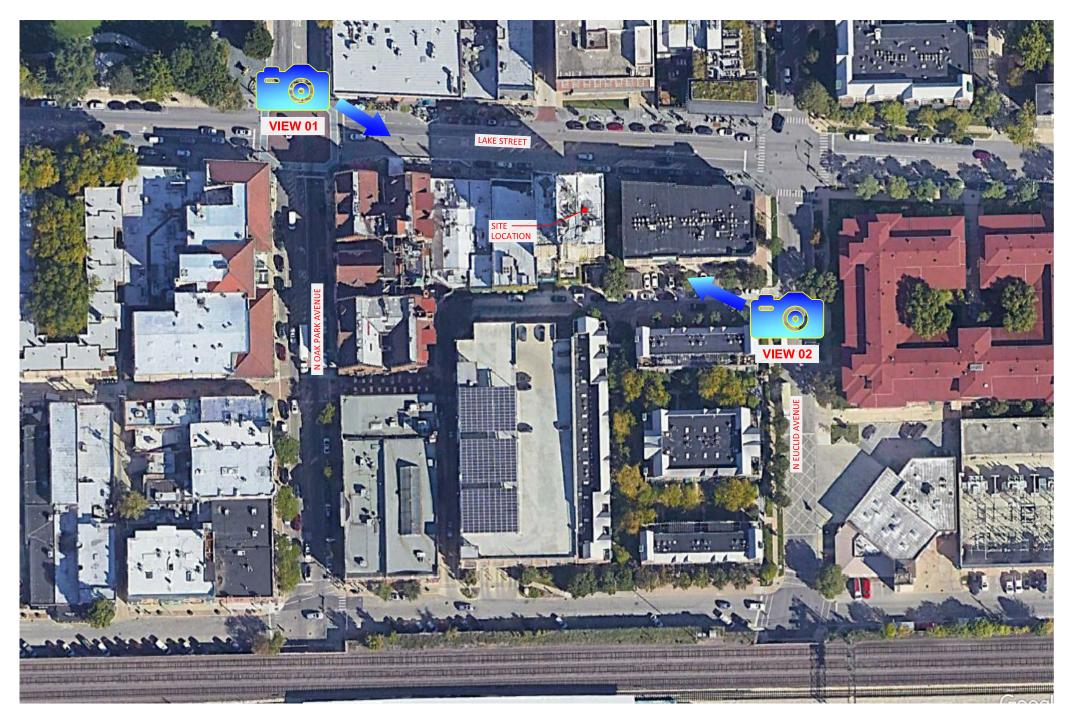

VICINITY AREA These depictions are for demonstrative purposes only. They are to be used in addition to the engineering drawings for an accurate representation of the site.







SITE ID: CHCHI00890C SITE ADDRESS: 715 LAKE ST. OAK PARK, IL 60301



### VIEW 01 - BEFORE (LOOKING SOUTHEAST)

# VIEW 01 - AFTER (LOOKING SOUTHEAST)

These depictions are for demonstrative purposes only. They are to be used in addition to the engineering drawings for an accurate representation of the

site.



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715 LAKE ST.



## VIEW 02 - BEFORE (LOOKING NORTHWEST)

# VIEW 02 - AFTER (LOOKING NORTHWEST)

These depictions are for demonstrative purposes only. They are to be used in addition to the engineering drawings for an accurate representation of the

site.

# dish wireless.

# Site Review: CHCHI00890C

05/28/24




# **Dish Network – Village of Oak Park Coverage Maps**



Mid-Band - Pre


Low-Band - Pre

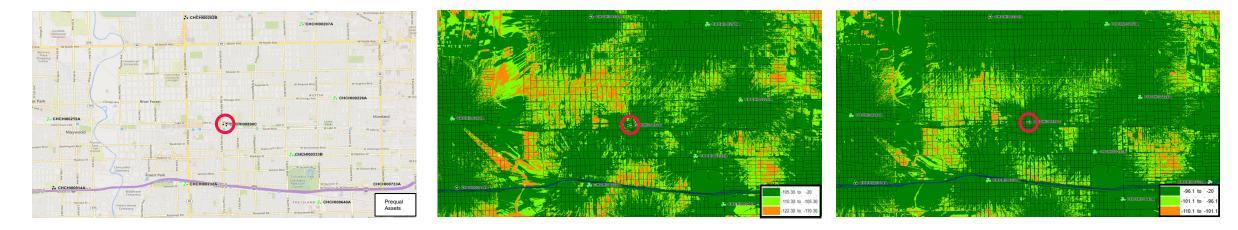

**Traffic Map** 

Mid-Band - Post

Low-Band - Post

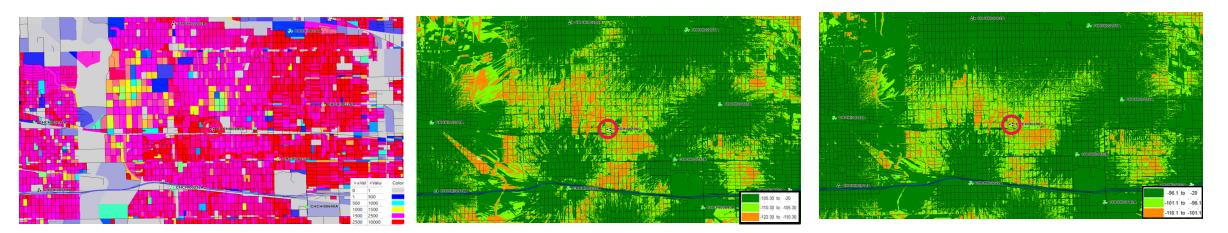

**CONFIDENTIAL AND PROPRIETARY INFORMATION** 

# Thank You

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RF-1     RF CABLE COLOR CODE         CALL 2 WORKING DAYS UTILITY NOTIFICATION PRIOR TO CONSTRUCTION		SITE LOCAT	TION
GN-1 LEGEND AND ABBREVIATIONS GENERAL NOTES		Park	
GN-Z RF SIGNAGE		AV	
GN-4 GENERAL NOTES THE FACILITY IS UNMANNED AND NOT FOR HUMAN HABITATION. A TECHNICIAN WILL VISIT THE SITE AS REQUIRED FOR ROUTINE MAINTENANCE. THE PROJECT WILL NOT RESULT IN ANY SIGNIFICANT DISTURBANCE OR EFFECT ON		0	
GN-5 GENERAL NOTES DRAINAGE. NO SANITARY SEWER SERVICE, POTABLE WATER, OR TRASH DISPOSAL IS REQUIRED AND NO COMMERCIAL SIGNAGE IS PROPOSED.			
S-1 STRUCTURAL NOTES AND DETAILS			
S-2 STRUCTURAL DETAILS 11"x17" PLOT WILL BE HALF SCALE UNLESS OTHERWISE NOTED			
S-4 STRUCTURAL DETAILS CONTRACTOR SHALL VERIFY ALL PLANS, EXISTING DIMENSIONS, AND CONDITIONS ON		Google	North
THE JOB SITE, AND SHALL IMMEDIATELY NOTIFY THE ENGINEER IN WRITING OF ANY DISCREPANCIES BEFORE PROCEEDING WITH THE WORK.		J. J	

# PROJECT DIRECTORY


- PPLICANT: DISH Wireless L.L.C. 5701 SOUTH SANTA FE DRIVE LITTLETON, CO 80120
- HTE DESIGNER: FULLERTON ENGINEERING 1100 E, WOODFIELD ROAD, STE. 500 SCHAUMBURG, IL 60173 (847) 908–8400
- ITE ACQUISITION: KEVIN HOM khom**G**fullerton-us.com ONSTRUCTION MANAGER: ANDREW LOVEJOY
- andrew.lovejoy@dish.com
  - faisal.syed@dish.com


### ONS


PORT: MP (RIGHT) ONTO 1-190.


#### Æ.




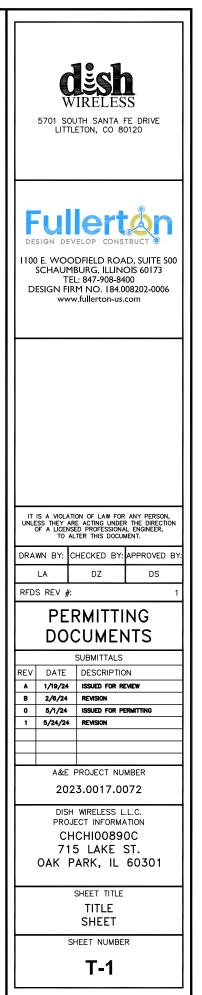

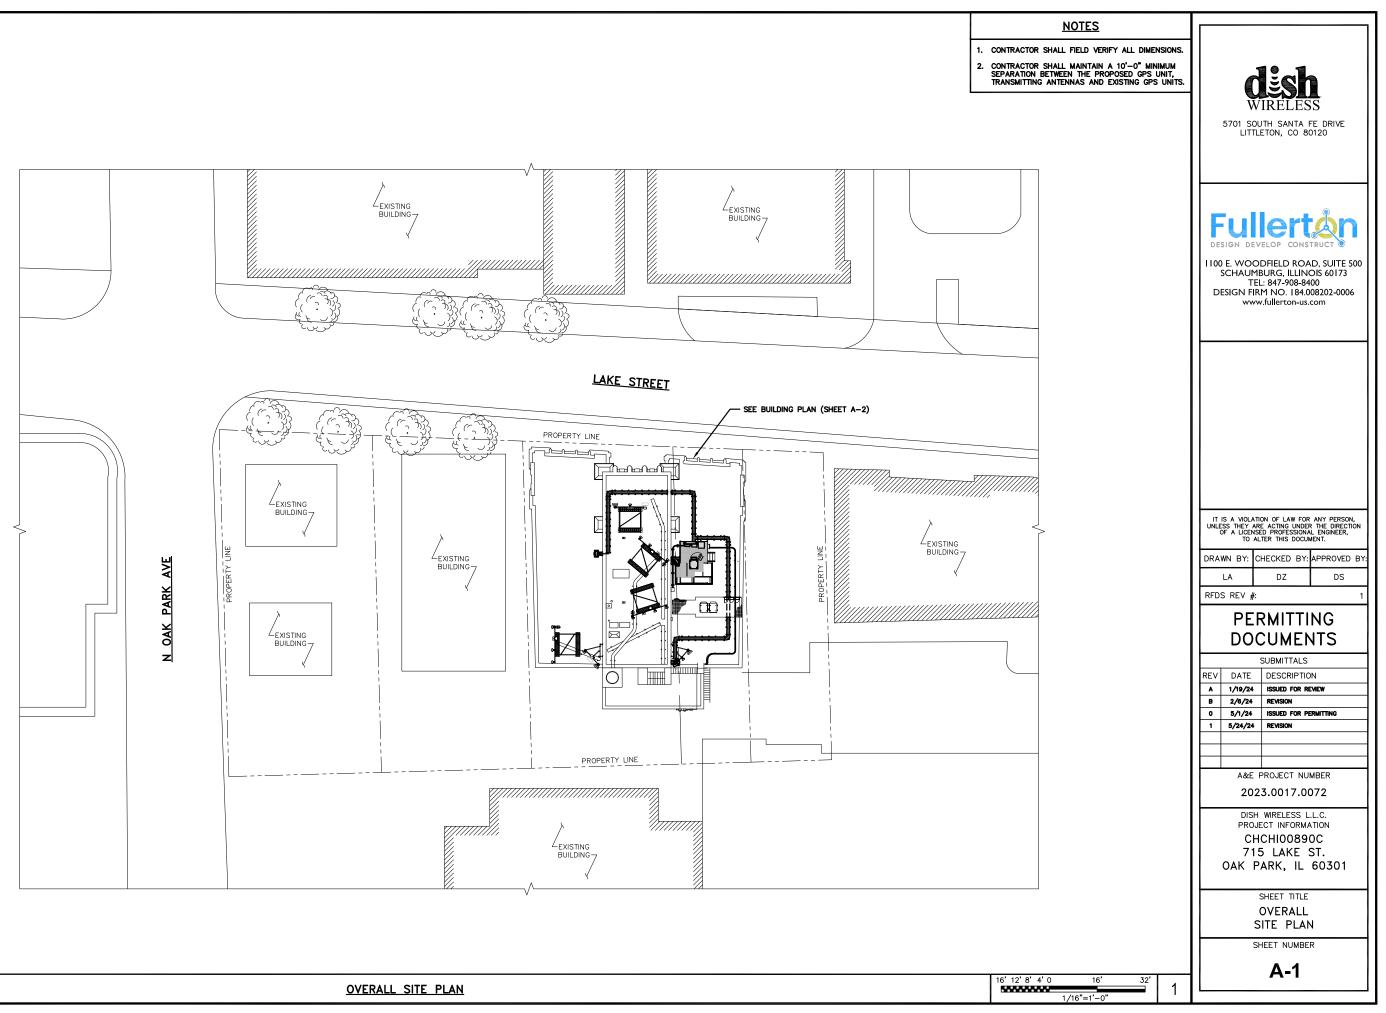

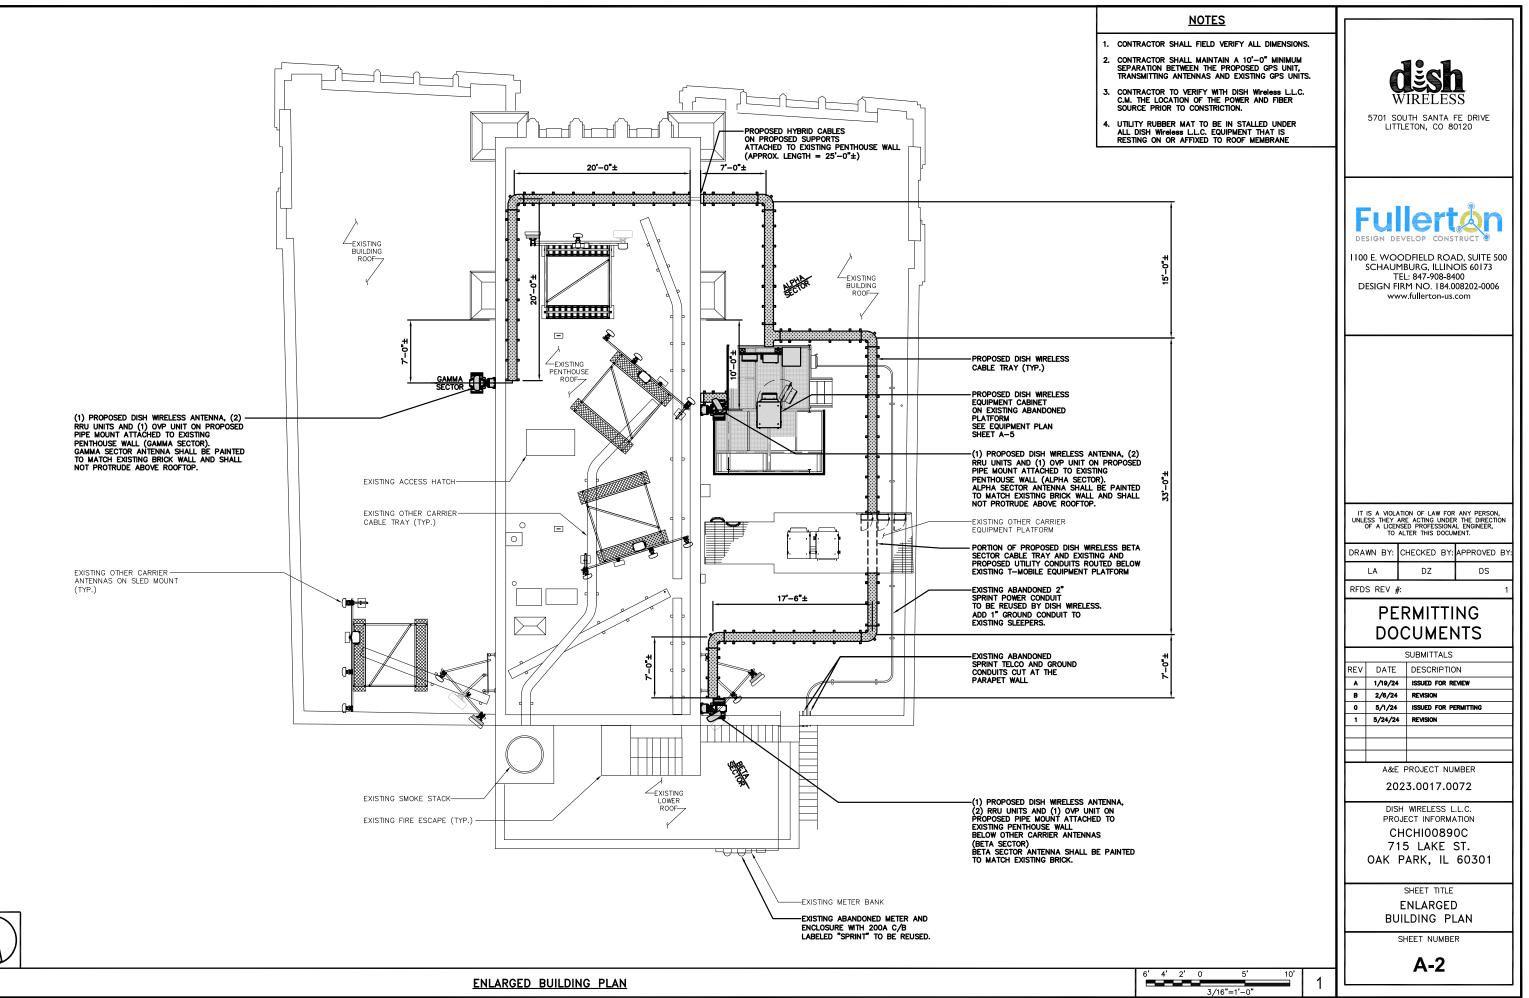

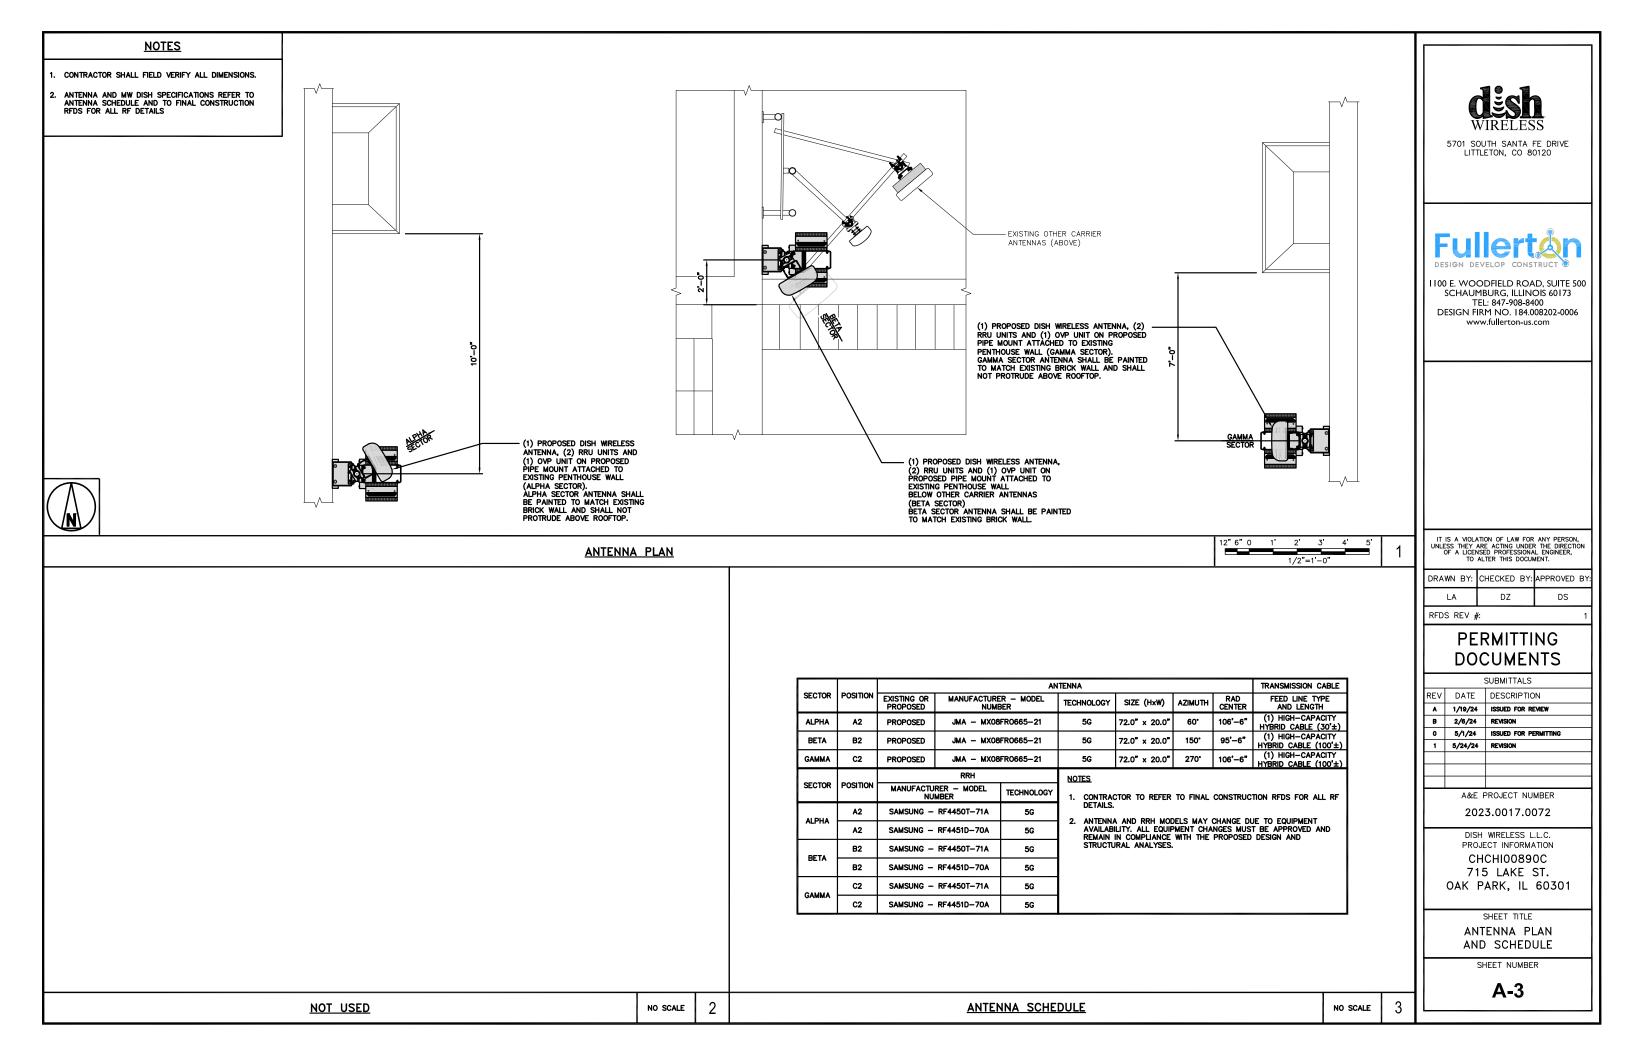

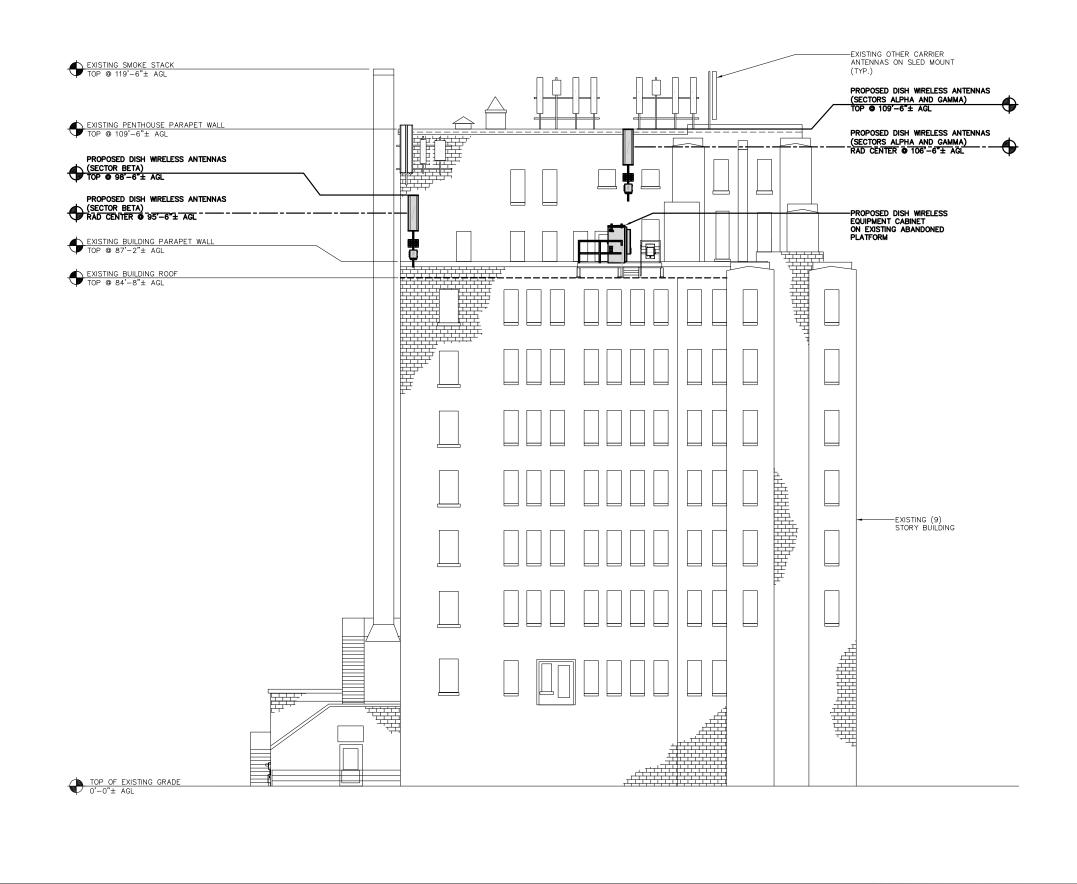

BUILDING ELEVATION

Ν	0	TE	S

1. CONTRACTOR SHALL FIELD VERIFY ALL DIMENSIONS.

 CONTRACTOR SHALL MAINTAIN A 10'-0" MINIMUM SEPARATION BETWEEN THE PROPOSED GPS UNIT, TRANSMITTING ANTENNAS AND EXISTING GPS UNITS.




5701 SOUTH SANTA FE DRIVE LITTLETON, CO 80120



I 100 E. WOODFIELD ROAD, SUITE 500 SCHAUMBURG, ILLINOIS 60173 TEL: 847-908-8400 DESIGN FIRM NO. 184.008202-0006 www.fullerton-us.com

IT IS A VIOLATION OF LAW FOR ANY PERSON, UNLESS THEY ARE ACTING UNDER THE DIRECTION OF A LICENSED PROFESSIONAL ENGINEER, TO ALTER THIS DOCUMENT.

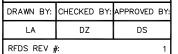

# PERMITTING DOCUMENTS

 SUBMITTALS

 REV
 DATE
 DESCRIPTION

 A
 1/19/24
 ISSUED FOR REVIEW

 B
 2/6/24
 REVISION

 0
 5/1/24
 ISSUED FOR PERMITTING

 1
 5/24/24
 REVISION

A&E PROJECT NUMBER

2023.0017.0072

DISH WIRELESS L.L.C. PROJECT INFORMATION CHCHI00890C 715 LAKE ST.

OAK PARK, IL 60301


SHEET TITLE

BUILDING ELEVATION


SHEET NUMBER

**A-4** 

8'	4'	0	8'	16'	4
			1/8"=1'-0"		1

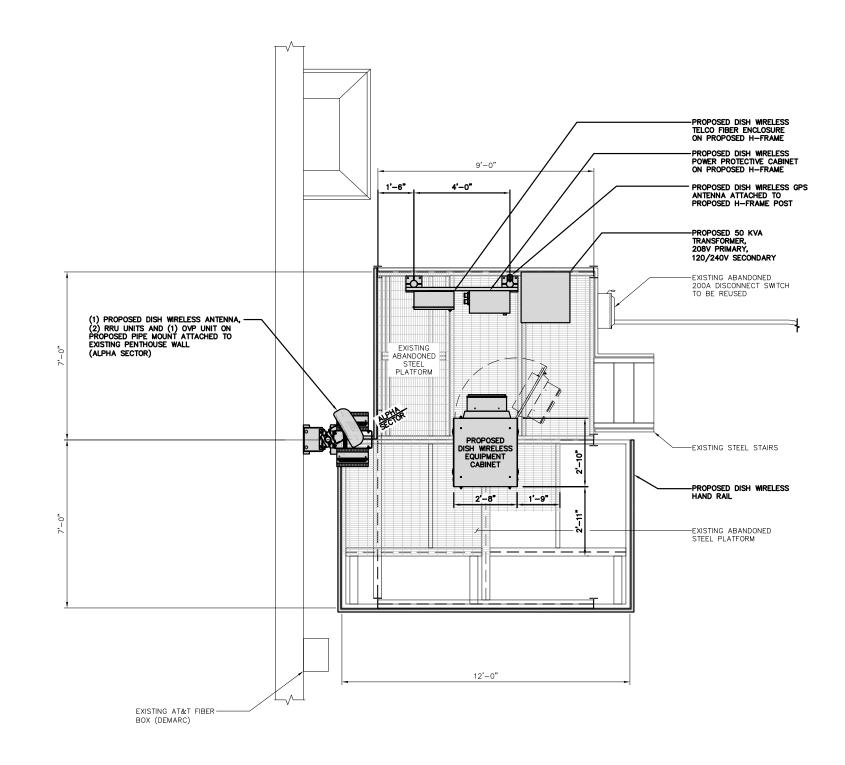





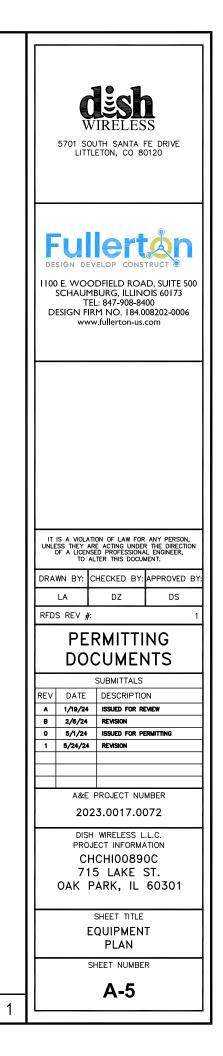

12" 6" 0 1'


2' 3' 4' 5' 1/2"=1'-0"

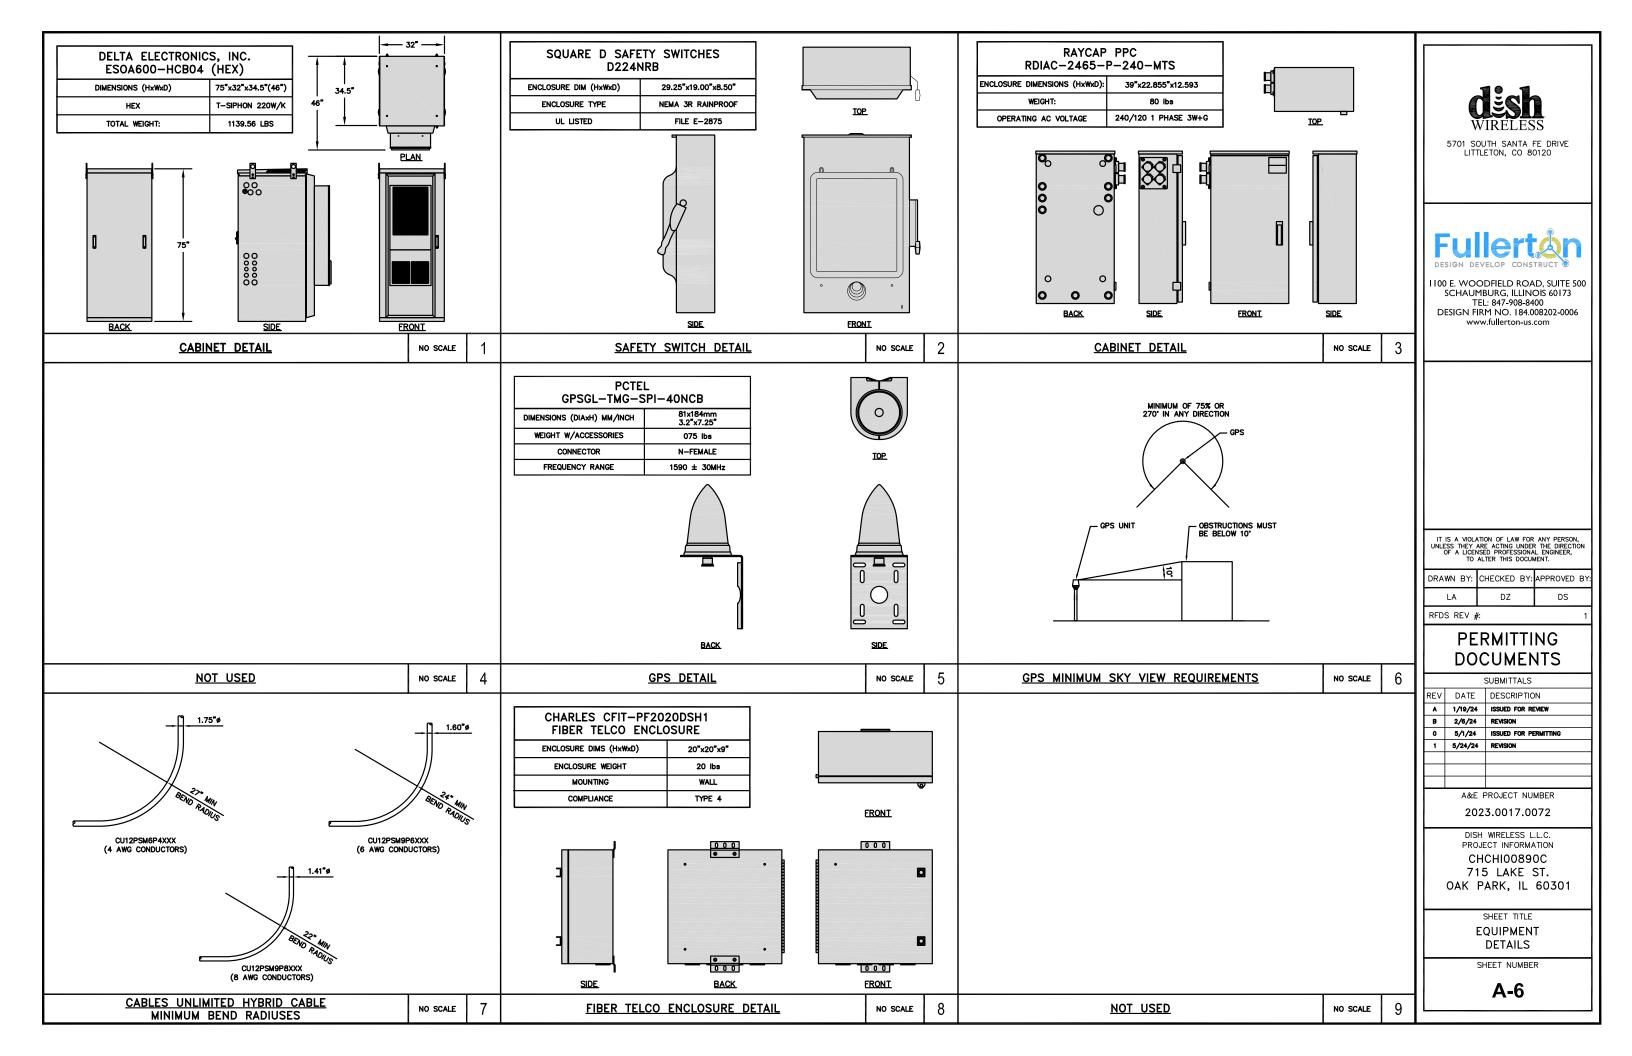

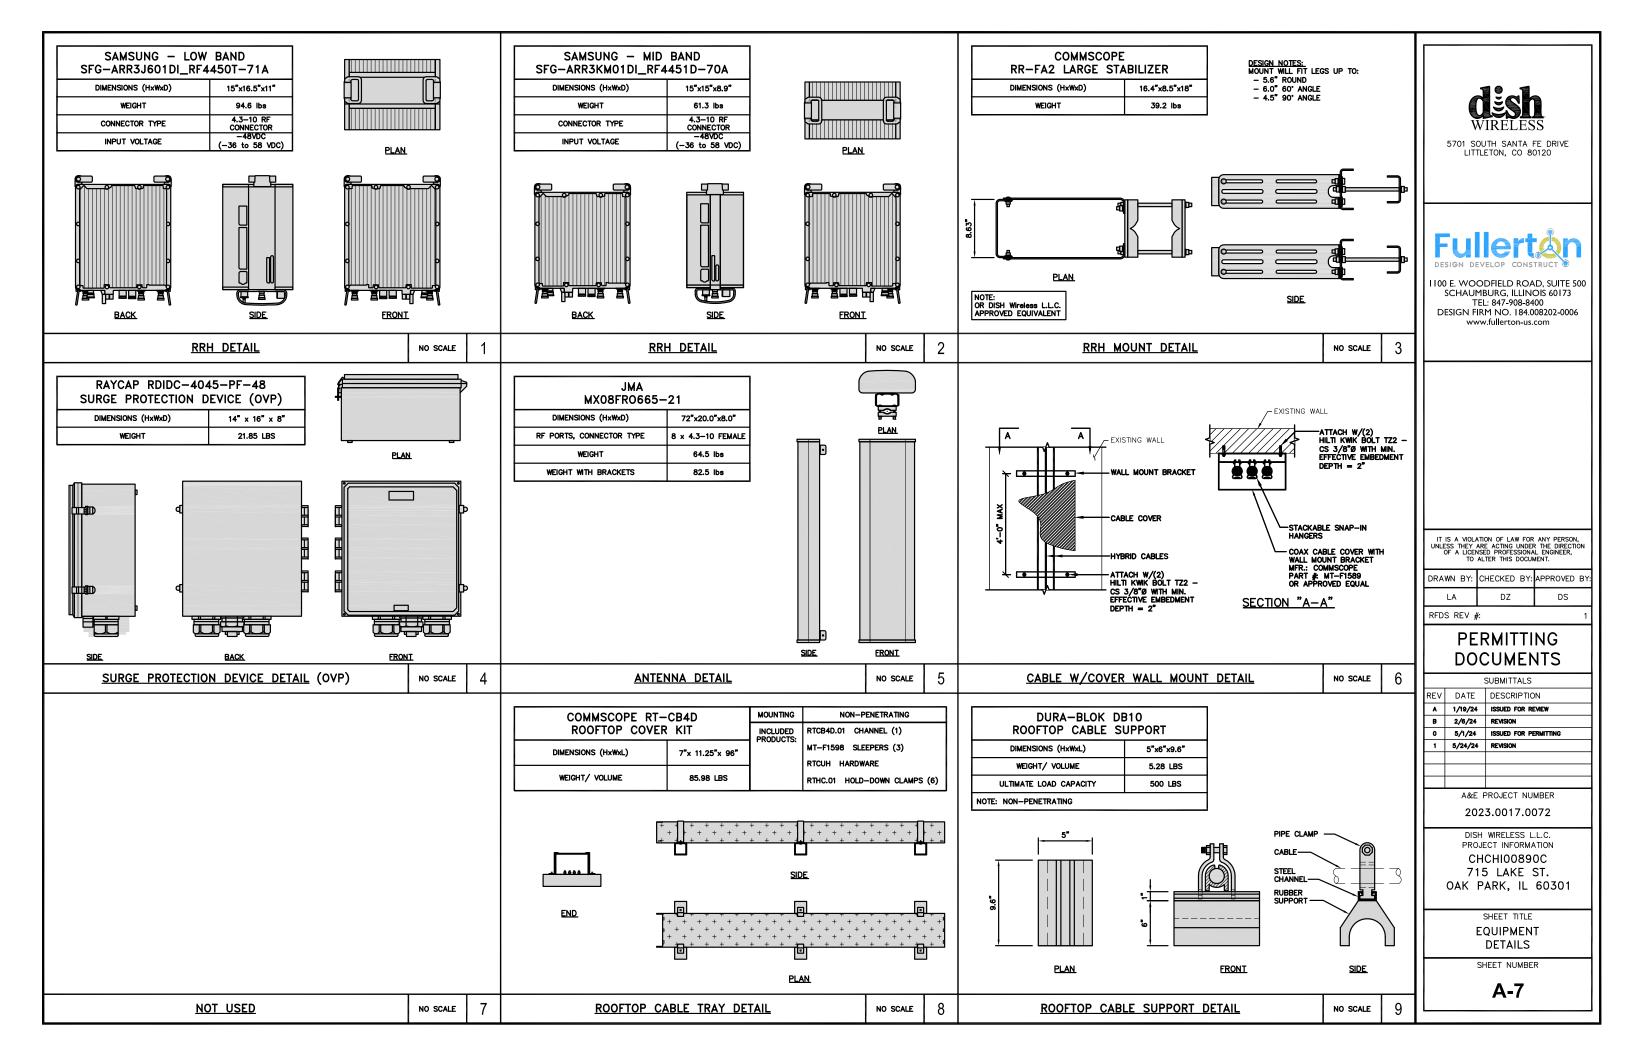




FINAL FIBER MEET-ME-POINT LOCATION TO BE CONFIRMED AND APPROVED BY FIBER PROVIDER ASSIGNED BY DISH WIRELESS. REFER TO FIBER DESIGN FORM FOR FINAL FIBER ROUTE.

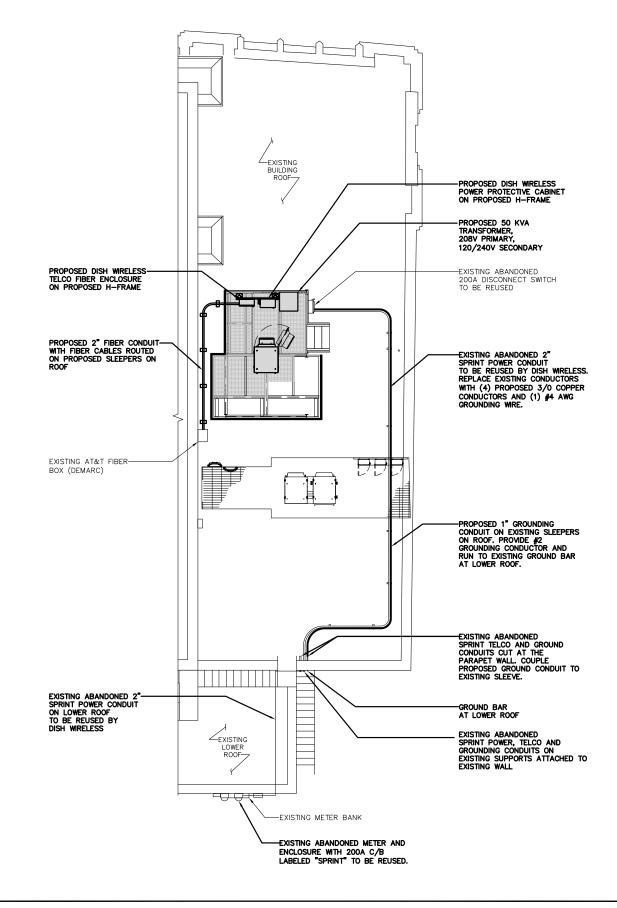





UTILITY PLAN

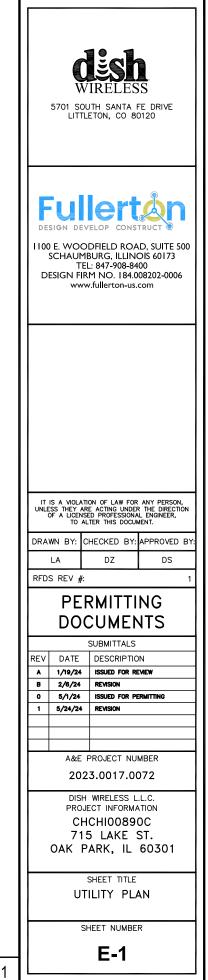


		20 DIS PRO CI 71 OAK	PROJECT NU 23.0017.00 H WIRELESS L JECT INFORMA HCHI0089 5 LAKE 5 LAKE PARK, IL SHEET TITLE SHEET TITLE SHEET NUMBE E-1	072 L.C. ATION OC ST. 60301 AN
		20 <sup>DIS PRO CI 71 OAK</sup>	23.0017.00 H WRELESS L JECT INFORMA HCHI0089 5 LAKE PARK, IL SHEET TITLE	072 L.C. ATION OC ST. 60301
		20 DIS PRO CI 71	23.0017.00 H WIRELESS L JECT INFORMA HCHI0089 5 LAKE PARK, IL	072 .L.C. ATION 0C ST. 60301
		20 DIS PRO CI 71	23.0017.00 H WIRELESS L JECT INFORMA HCHI0089 5 LAKE	072 L.C. ATION 0C ST.
		20 DIS PRC C	23.0017.00 H WIRELESS L JECT INFORMA	072 L.C. ATION 0C
		20	23.0017.00	072
	1	5/24/24	REVISION	
	B	2/6/24 5/1/24	REVISION ISSUED FOR PI	ERMITTING
	A	1/19/24		Eview
	REV	DATE	DESCRIPTIC	N
		00	SUBMITTALS	113
			RMITTI CUMEN	
	RFD:	S REV #		
		LA	DZ	DS
	DRA	WN BY:	CHECKED BY:	APPROVED
		SS THEY A	TION OF LAW FOR ARE ACTING UNDER ISED PROFESSIONA ALTER THIS DOCUM	R THE DIRECTI AL ENGINEER, MENT.
	Пт	IS A VIOLA	TION OF LAW FOR	ANY PERSON
			EL: 847-908-84 RM NO. 184.0 /w.fullerton-us.	08202-0006


DC POWER WIRING SHALL BE COLOR CODED AT EACH END FOR IDENTIFYING +24V AND -48 RED MARKINGS SHALL IDENTIFY +24V AND BLUE MARKINGS SHALL IDENTIFY -48V.	BV CONDUCTOR	s.	DISH Wireless LLC. C C C C C C C C C C C C C C C C C	SH Wireless L.L.C. FIBI STRIBUTION PANEL. ROPOSED DISH Wireless	s L.L.C.	
<ol> <li>CONTRACTOR SHALL INSPECT THE EXISTING CONDITIONS PRIOR TO SUBMITTING A BID. ANY J. DURING THE BID PERIOD IN REGARDS TO THE CONTRACTOR'S FUNCTIONS. THE SCOPE OF W. OTHER ISSUE RELATED TO THIS PROJECT SHALL BE BROUGHT UP DURING THE BID PERIOD MANAGER FOR CLARIFICATION, NOT AFTER THE CONTRACT THAS BEEN AWARDD.</li> <li>ALL ELECTRICAL WORK SHALL BE DONE IN ACCORDANCE WITH CURRENT NATIONAL ELECTRIC STATE AND LOCAL CODES, LAWS, AND ORDINANCES. PROVIDE ALL COMPONENTS AND WIRNOR REQUIRED TO MEET HACE STANDARDS.</li> <li>LOCATION OF EQUIPMENT, CONDUIT AND DEVICES SHOWN ON THE DRAWINGS ARE APPROXIM COORDINATED WITH FIELD CONDITIONS PRIOR TO CONSTRUCTION.</li> <li>CONDUIT ROUGH-IN SHALL BE COORDINATED WITH THE MECHANICAL EQUIPMENT TO AVOID I CONFLICTS. VERIFY WITH THE MECHANICAL EQUIPMENT CONTRACTOR AND CONFLY AS REQUIRED STEEM.</li> <li>CONTRACTOR SHALL PROVIDE ALL BREAKERS, CONDUITS AND CIRCUITS AS REQUIRED FOR A SYSTEM.</li> <li>CONTRACTOR SHALL PROVIDE ALL BREAKERS, CONDUITS AND CIRCUITS AS REQUIRED BY THE NEX INSTALLATION SHALL BE IN ACCORDANCE WITH MANUFACTURER'S SPECIFICATIONS AND RECC A ILL DISCONNECTS AND CONTROLLING DEVICES SHALL BE PROVIDED WITH ENGRAVED PHENON INDICATING EQUIPMENT CONTROLLING DEVICES SHALL BE ROWDED WITH ENGRAVED PHENON INDICATING EQUIPMENT CONTROLLING DEVICES SHALL BE DONDED AT ALL JUNCTION BOXES, PU DISCONNECT SMITCHES, AND EQUIPMENT CABINETS.</li> <li>ALL DISCONNECT SMITCHES, AND EQUIPMENT CABINETS.</li> <li>ALL DISCONNECT SMITCHES, AND EQUIPMENT CABINETS.</li> <li>ALL M EQUIPMENT GROUNDING CONDUCTORS SHALL BE DONDED AT ALL JUNCTION BOXES, PU DISCONNECT SMITCHES, AND EQUIPMENT CABINETS.</li> <li>ALL NEW MATERIAL SHALL HAVE A U.L LABEL</li> <li>PANEL SCHEDULE LOADING AND CIRCUIT ARRANGEMENTS REFLECT POST-CONSTRUCTION EQUIPMENT THE EQUIPMENT GROUNDING CONDUCTORS SHALL BE BONDED AT ALL JUNCTION BOXES, PU DISCONNECT SMITCHES, AND EQUIPMENT CABINETS.</li> <li>ALL NEW MATERIAL SHALL HAVE A U.L LABEL</li> <li>PANEL SCHEDULE LOADING AND C</li></ol>	NORK, OR ANY WITH THE PRO. CAL CODES ANI G SIZES AS MATE AND SHAL LOCATION JIRED. A COMPLETE C ARTICLE 314 ASSEMBLIES. OMMENDATIONS FED S AND NEC 250 ILL BOXES, AND NUIPMENT.	JECT DALL LBE	PROPOSED DISH Wireless LLC. UNISTRUT PROPOSED DISH Wireless LLC. 10 AMP DISTRIBUTION BREAKER PROPOSED DISH Wireless LLC. 12 AWG WRE PROPOSED DISH Wireless LLC. 1-1/2" POWER FROM CABINET DISH Wireless LLC. INSTALLS 1-1/2" CONDUTS FOR POWER	SH Wireless LL.C. FIB IMPER TO CABINET WI EED TO BE TERMINATE BER PROVDER ON OT DE OF BULKHEAD/LC DNNECTOR WHERE CIR TERMINATED. ROPOSED FIBER PROVI BER LATERAL FROM GHT OF WAY TO STRE RAMINATED TO FOP ROPOSED DISH Wireless 'CONDUIT FROM COM BER VAULT NO SCALE	E ER LL DD BY HER TO LC CUIT DER EET, s LL.C. s LL.C.	PROPOSED DISH Wireless LLC. PROPOSED FIBER PROVIDER 1-1/4" FLEX CONDUITS FIBER PROVIDER TO TERMINATE POWER TO FIBER PROVIDER NID PROPOSED DISH Wireless LLC. 12 AWG WIRE (6' TALL) PROPOSED DISH Wireless LLC. 12 AWG WIRE PROPOSED DISH Wireless LLC. 1-1/2" POWER FROM CABINET LIT TELCO BOX — INTERIOR WIRING L
ELECTRICAL NOTES	NO SCALE	1	NOT_USED	NO SCALE	4	NOT USED
					1	
NOT USED	NO SCALE	6	NOT_USED	NO SCALE	7	NOT USED

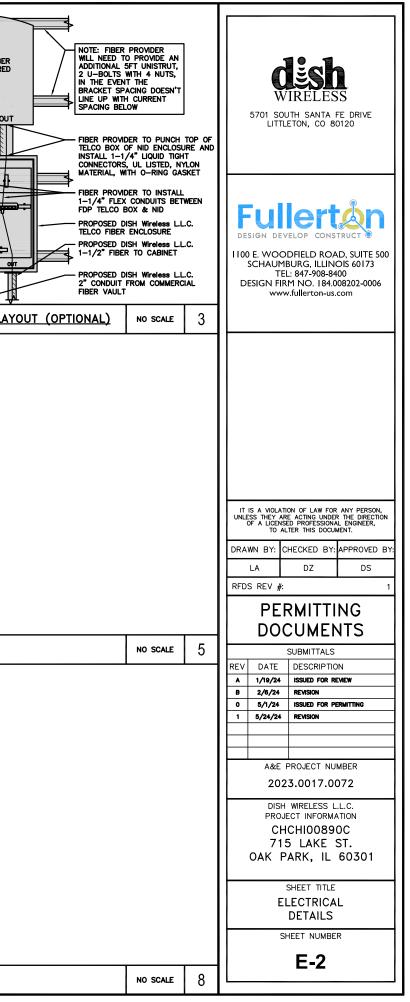

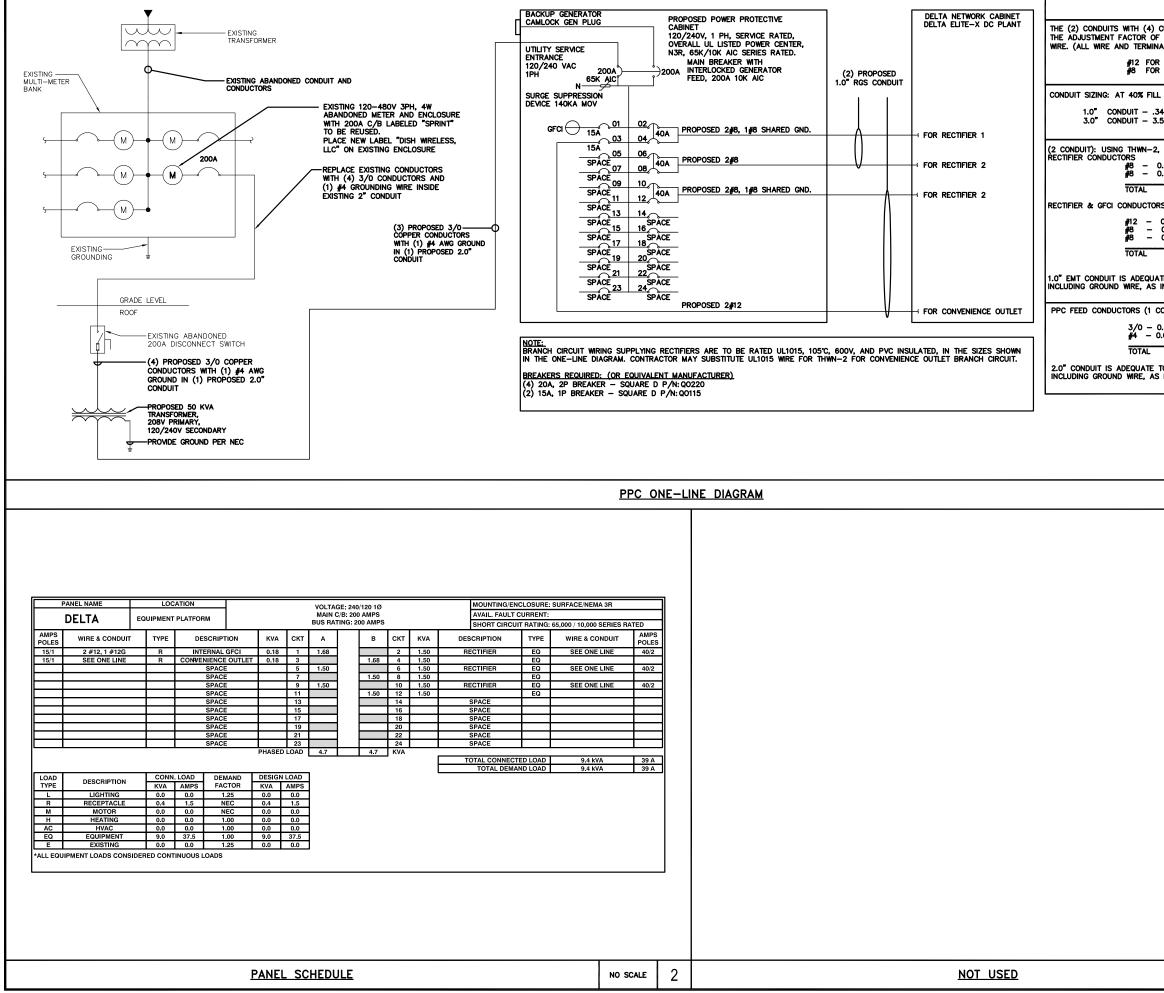

<u>NOTES</u>						]
CURRENT CARRYING CONDUCTORS E F 80% PER 2020 NEC TABLE 310.15( JATION HARDWARE TO BE RATED 751	(C)(1) FOR UL					
R 20A OCPD WIRE DERATING: 0.8 WIRE DERATING: 0.8 WIRE DERATING: 0.8					dësi	
L PER NEC CHAPTER 9, TABLE 4, A	rticle 358.			Ĭ	VIRELE	SS
3460 SQ. IN AREA .538 SQ. IN AREA					OUTH SANTA TLETON, CO 8	
, CU.						
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= 0.1830 SQ. IN RS	-					
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				DIS	H WIRELESS	L.L.C.
				PRO	DJECT INFORM	ATION
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				ΟΑΚ	PARK, IL	60301
					SHEET TITLI	Ξ
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				and F	PANEL SC	
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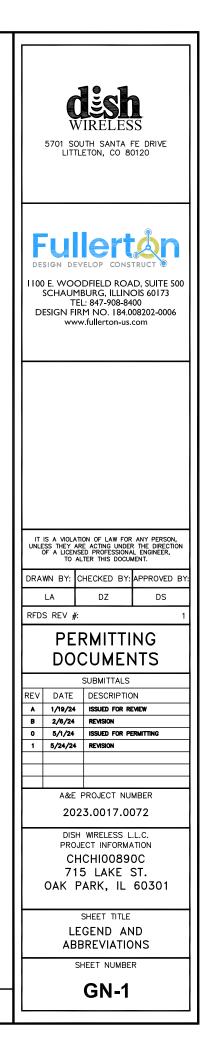
	RF JUMPER COLOR CODING		3/4" TAPE WIDTHS WITH 3/4" SPACING				
	LOW-BAND RRH — (600MHz N71 BASEBAND) + (850MHz N26 BAND) + (700MHz N29 BAND) — OPTIONAL PER MARKET	PORT 1 PORT 2 PORT 3 PORT + SLANT - SLANT + SLANT - SLAN	4 PORT 1 PORT 2 PORT 3 PORT 4 P NT + SLANT - SLANT + SLANT - SLANT	ORT 1 PORT 2 PORT 3 PORT 4 SLANT - SLANT + SLANT - SLANT		OPTIONAL – (N29)	(N66+N70+H-BLOCK)
Be have be ware,	ADD FREQUENCY COLOR TO SECTOR BAND (CBRS WILL USE YELLOW BANDS)		GE CARAGE ORANGE			(3 GHz)	ON ANT/RRH
Market 12 Water 12 Water 12 Water 1       Duff 2       Duff 2       Duff 2       Duff 2       Duff 2         Market 12 Water 12 Water 12       Duff 2       Duff 2       Duff 2       Duff 2       Duff 2         Market 12 Water 12 Water 12       Duff 2       Duff 2       Duff 2       Duff 2       Duff 2         Market 12 Water 12       Duff 2       Duff 2       Duff 2       Duff 2       Duff 2       Duff 2         Market 12 Water 12       Duff 2         Market 12 Water 12       Duff 2       Duff 2 <td>MID-BAND RRH – (AWS BANDS N66+N70)</td> <td></td> <td></td> <td></td> <td></td> <td></td> <td>GAMMA SEC</td>	MID-BAND RRH – (AWS BANDS N66+N70)						GAMMA SEC
	ADD FREQUENCY COLOR TO SECTOR BAND (CBRS WILL USE YELLOW BANDS)			(-) PORT		COLOR IDENTIFIER	NO SCALE
	HYBRID/DISCREET CABLES	EXAMPLE 1 EXAMPLE 2	EXAMPLE 3				
	NCLUDE SECTOR BANDS BEING SUPPORTED		RED				
	EXAMPLE 1 - HYBRID, OR DISCREET, SUPPORTS ALL SECTORS, BOTH LOW-BANDS AND MID-BANDS						
	EXAMPLE 2 – HYBRID, OR DISCREET, SUPPORTS CBRS ONLY, ALL SECTORS						
	FIBER JUMPERS TO RRHs	LOW BAND RRH HIGH BAND RRH	LOW BAND RRH HIGH BAND RRH LOW	BAND RRH HIGH BAND RRH			
	LOW-BAND RRH FIBER CABLES HAVE SECTOR STRIPE ONLY						
IRFE ORLY IRFE O	POWER CABLES TO RRHs	LOW BAND RRH HIGH BAND RRH	LOW BAND RRH HIGH BAND RRH LOW	BAND RRH HIGH BAND RRH			
ET MOTORS AT ANTENNAS UNTERNA 1 ANTENNA 1 ANTE	LOW-BAND RRH POWER CABLES HAVE SECTOR STRIPE ONLY	RED RED	BLUE BLUE C	REEN GREEN			I
LOW BAND/ HIGH BAND/ INC INC INC INC INC INC INC INC		PURPLE	PURPLE	PURPLE		NOT USED	NO SCALE
ICROWAYE RADIO LINKS FORWARD AZMUTH OF 0-120 DEGREES FORWARD AZMUTH OF 120-240 DEGREES FORWARD AZMUTH OF 240-360 DEGREES NKS WILL HAVE A 1.5-2 INCH WHITE WRAP WITH WRATE WANTE WANDS FOR LACH DUROWAYE RADIO LINKS FORWARD AZMUTH OF 0-120 DEGREES FORWARD AZMUTH OF 240-360 DEGREES NKS WILL HAVE A 1.5-2 INCH WHITE WRAP WITH WRATE WILL REQUIRE P-TOUCH WRATE WILTE WATE WATE WATE WATE WATE WATE WATE WA	RET MOTORS AT ANTENNAS	LOW BAND/ HIGH BAND/	LOW BAND/ HIGH BAND/ LOW	BAND/ HIGH BAND/			
CROWARD AZIMUTH OF 0-120 DEGREES FORMARD AZIMUTH OF 120-240 DEGREES FORMARD AZIMUTH OF 20-360 DEGREES		RED	BLUE	GREEN GREEN			
HE AZIMUTH COLOR OVERLAPPING IN THE MIDDLE. DO ADDITIONAL SECTOR COLOR BANDS FOR EACH DDITIONAL MW RADIO. CROWAVE CABLES WILL REQUIRE P-TOUCH ABELS INSIDE THE CABINET TO IDENTIFY THE DCAL AND REMOTE SITE ID'S WHITE W	MICROWAVE RADIO LINKS	CORWARD AZIMUTH OF 0-120 DEGREES FO	RWARD AZIMUTH OF 120-240 DEGREES FORWARD A	ZIMUTH OF 240-360 DEGREES			
	LINKS WILL HAVE A 1.5-2 INCH WHITE WRAP WITH THE AZIMUTH COLOR OVERLAPPING IN THE MIDDLE. ADD ADDITIONAL SECTOR COLOR BANDS FOR EACH ADDITIONAL MW RADIO. MICROWAVE CABLES WILL REQUIRE P-TOUCH LABELS INSIDE THE CABINET TO IDENTIFY THE LOCAL AND REMOTE SITE ID'S	WHITE RED WHITE WHITE	WHITE WHITE C	MHITE WHITE SREEN GREEN MHITE WHITE			
RF CABLE COLOR CODES     NO SCALE     1     NOT USED     No scale	LOONE MYD NEMOTE SITE ID S						
	RF	CABLE COLOR CODES		NO SCALE	1	NOT_USED	NO SCALE

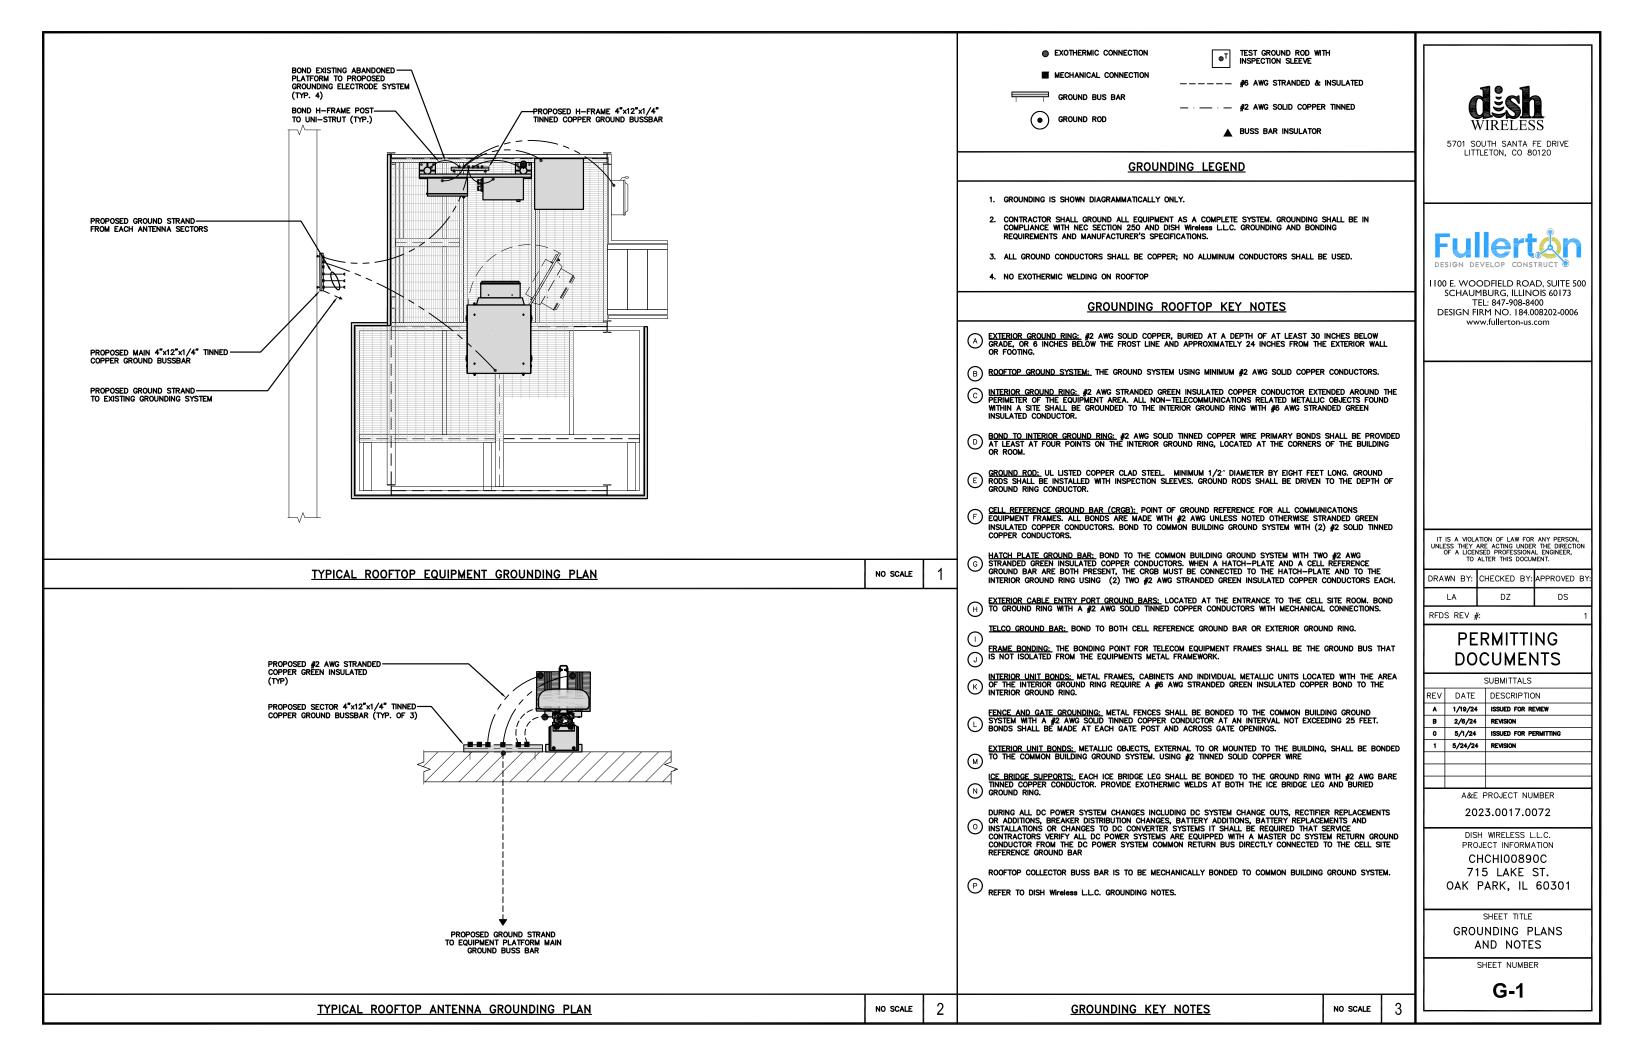LOW BANDS (N71+N26) OPTIONAL - (N29) ORANGE CBRS TECH (3 GHz) YELLOW		AWS (N66+N70+H-BLOCK) PURPLE NEGATIVE SLANT PORT ON ANT/RRH WHITE	_	<b>DESC</b> WIRELESS 5701 SOUTH SANTA FE DRIVE LITTLETON, CO 80120
RED	BETA SECTOR	GAMMA SECTOR		Fullertion-us.com
OLOR IDENTIFIER		NO SCALE	2	
				IT IS A VIOLATION OF LAW FOR ANY PERSON, UNLESS THEY ARE ACTING UNDER THE DIRECTION OF A LICENSED PROFESSIONAL BUGNET. DRAWN BY: CHECKED BY: APPROVED BY: LA DZ DS RFDS REV #: 1 PERMITTING DOCUMENTS
NOT USED		NO SCALE	3	SUBMITTALS REV DATE DESCRIPTION
				A 1/19/24 ISSUED FOR REVIEW B 2/6/24 REVISION 0 5/1/24 ISSUED FOR PERMITTING 1 5/24/24 REVISION A&E PROJECT NUMBER 2023.0017.0072 DISH WIRELESS L.L.C. PROJECT INFORMATION CHCHI00890C 715 LAKE ST. OAK PARK, IL 60301 SHEET TITLE RF CABLE COLOR CODE SHEET NUMBER RF-1
NOT USED			_	

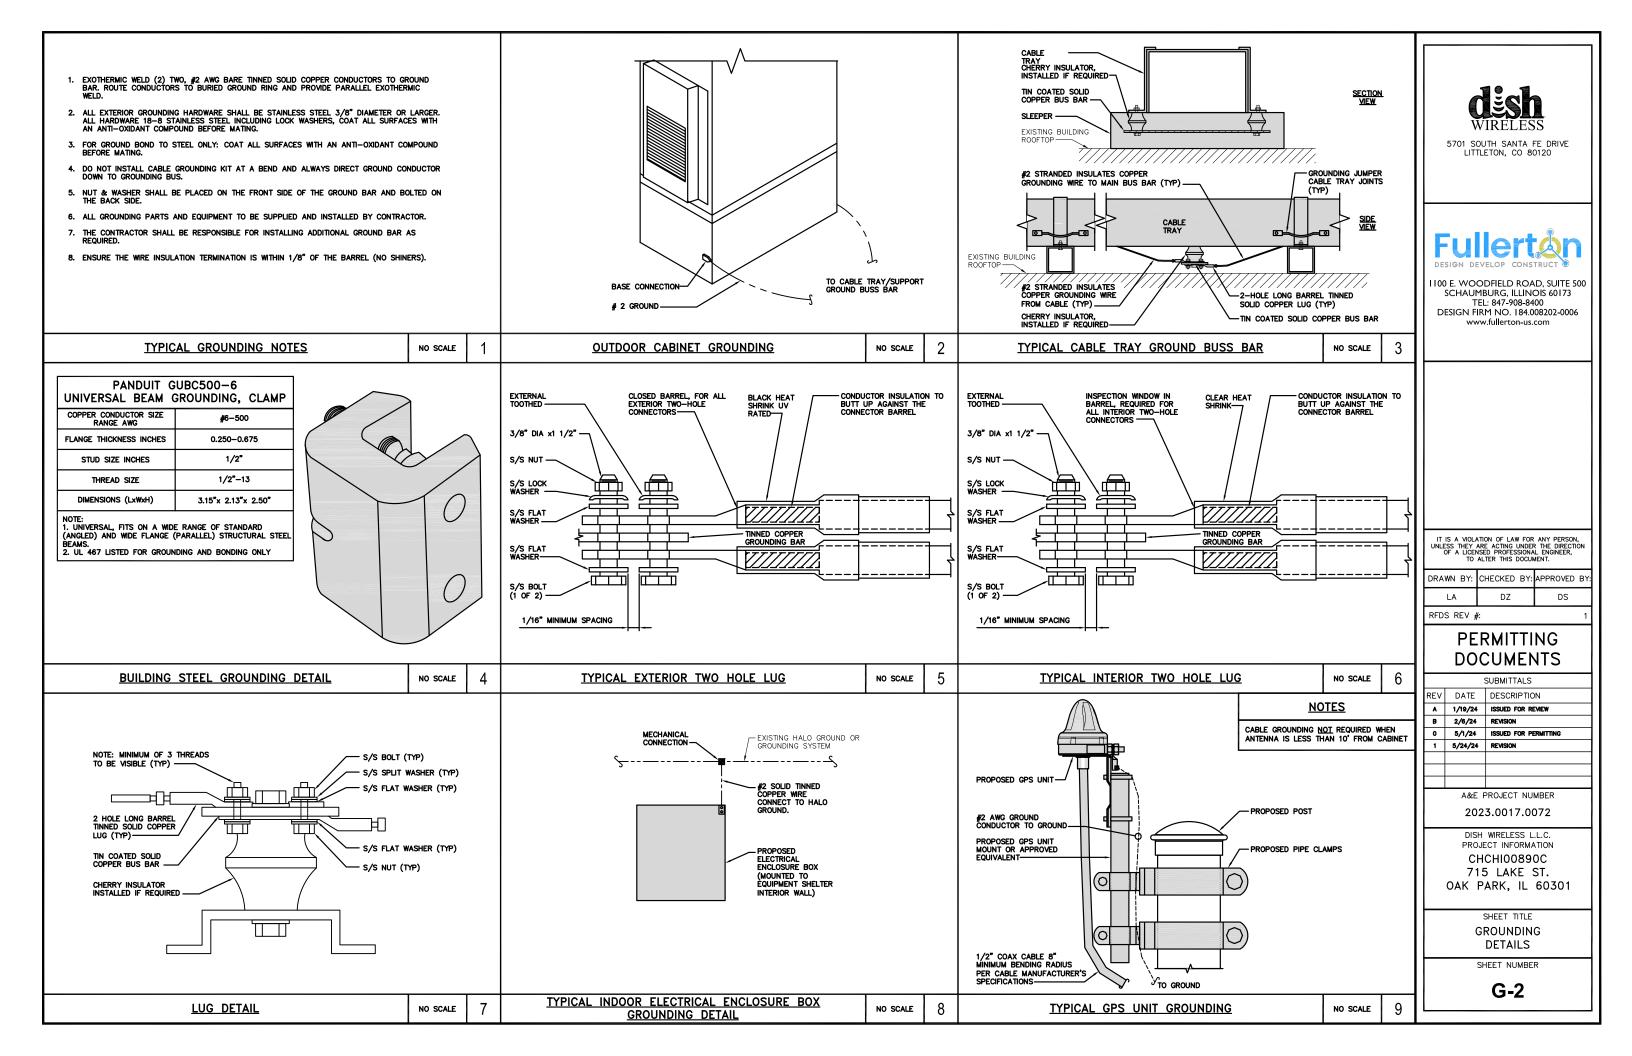EXOTHERMIC CONNECTION	•	AB ABV	ANCHOR BOLT ABOVE
MECHANICAL CONNECTION		AC	ALTERNATING CURRENT
BUSS BAR INSULATOR		ADDL	ADDITIONAL
CHEMICAL ELECTROLYTIC GROUNDING SYSTEM	$\mathbf{\Theta}$	AFF	ABOVE FINISHED FLOOR
TEST CHEMICAL ELECTROLYTIC GROUNDING SYSTEM		AFG	ABOVE FINISHED GRADE
	<b>Ø</b> ⊺	AGL	ABOVE GROUND LEVEL
EXOTHERMIC WITH INSPECTION SLEEVE		AIC ALUM	AMPERAGE INTERRUPTION C. ALUMINUM
GROUNDING BAR		ALT	ALTERNATE
GROUND ROD	_●	ANT	ANTENNA
TEST GROUND ROD WITH INSPECTION SLEEVE	ı <b> ⊢⊕</b> ⊤	APPROX	APPROXIMATE
		ARCH	ARCHITECTURAL
SINGLE POLE SWITCH	\$	ATS AWG	AUTOMATIC TRANSFER SWIT
DUPLEX RECEPTACLE	ф.	BATT	BATTERY
DUPLEX GFCI RECEPTACLE		BLDG BLK	BUILDING BLOCK
FLUORESCENT LIGHTING FIXTURE (2) TWO LAMPS 48		BLKG BM	BLOCKING BEAM
		втс	BARE TINNED COPPER CONE
SMOKE DETECTION (DC)	(SD)	BOF	BOTTOM OF FOOTING
		CAB	CABINET
EMERGENCY LIGHTING (DC)	, <del>, , , , , , , , , , , , , , , , , , </del>	CANT	CANTILEVERED
		СНС	CHARGING
SECURITY LIGHT W/PHOTOCELL LITHONIA ALXW		CLG CLR	CEILING CLEAR
LED-1-25A400/51K-SR4-120-PE-DDBTXD		COL	COLUMN
CHAIN LINK FENCE	x x x x	COL	COMMON
WOOD/WROUGHT IRON FENCE		CONC	CONCRETE
WALL STRUCTURE		CONSTR	CONSTRUCTION
		DBL	DOUBLE
LEASE AREA		DC	DIRECT CURRENT
PROPERTY LINE (PL)		DEPT	DEPARTMENT
SETBACKS		DF	DOUGLAS FIR
ICE BRIDGE		DIA	DIAMETER
		DIAG	DIAGONAL
CABLE TRAY		DIM	DIMENSION
WATER LINE	— w — w — w — w — w —	DWG	DRAWING
UNDERGROUND POWER		DWL EA	DOWEL EACH
UNDERGROUND TELCO	—— UGT —— UGT —— UGT —— UGT ——	EC	ELECTRICAL CONDUCTOR
		EL.	ELEVATION
OVERHEAD POWER		ELEC	ELECTRICAL
OVERHEAD TELCO	OHT OHT OHT	EMT	ELECTRICAL METALLIC TUBIN
UNDERGROUND TELCO/POWER		ENG	ENGINEER
ABOVE GROUND POWER	AGP AGP AGP AGP	EQ	EQUAL
ABOVE GROUND TELCO	AGT AGT AGT AGT	EXP	EXPANSION
		EXT	EXTERIOR
ABOVE GROUND TELCO/POWER	AGT/P AGT/P AGT/P	EW	EACH WAY
WORKPOINT	W.P.	FAB FF	FABRICATION FINISH FLOOR
	XX	FG	FINISH FLOOR
SECTION REFERENCE	$\left(\frac{x}{x-x}\right)$	FIF	FACILITY INTERFACE FRAME
		FIN	FINISH(ED)
	-	FLR	FLOOR
	XX	FDN	FOUNDATION
DETAIL REFERENCE	X-X	FOC	FACE OF CONCRETE
	Ŭ	FOM	FACE OF MASONRY
		FOS	FACE OF STUD
		FOW	FACE OF WALL
		FS	FINISH SURFACE
		FT	FOOT
		FTG	FOOTING
		GA GEN	GAUGE GENERATOR
		GEN GFCI	GROUND FAULT CIRCUIT INT
		GLB	GLUE LAMINATED BEAM
		GLV	GALVANIZED
		GPS	GLOBAL POSITIONING SYSTE
		GND	GROUND
		GSM	GLOBAL SYSTEM FOR MOBIL
		HDG	HOT DIPPED GALVANIZED
		HDR	HEADER
		HGR	HANGER
		HVAC	HEAT/VENTILATION/AIR CON
		HT	height Interior ground ring

IN	INCH
	INTERIOR
LB(S)	POUND(S)
LF	LINEAR FEET
	LONG TERM EVOLUTION
	MASONRY
	MAXIMUM MACHINE BOLT
	MECHANICAL
	MANUFACTURER
MGB	MASTER GROUND BAR
	MINIMUM
	MISCELLANEOUS
	METAL MANUAL TRANSFER SWITCH
	MICROWAVE
NEC	NATIONAL ELECTRIC CODE
NM	NEWTON METERS
	NUMBER
#	NUMBER
	NOT TO SCALE ON-CENTER
	OCCUPATIONAL SAFETY AND HEALTH ADMINISTRATION
OPNG	OPENING
P/C	PRECAST CONCRETE
PCS	PERSONAL COMMUNICATION SERVICES
PCU	PRIMARY CONTROL UNIT
PRC	PRIMARY RADIO CABINET
PP PSF	POLARIZING PRESERVING
PSF	POUNDS PER SQUARE FOOT POUNDS PER SQUARE INCH
	PRESSURE TREATED
	POWER CABINET
QTY	QUANTITY
	RADIUS
	RECTIFIER
ref Reinf	REFERENCE REINFORCEMENT
	REQUIRED
	REMOTE ELECTRIC TILT
	RADIO FREQUENCY
RMC	RIGID METALLIC CONDUIT
	REMOTE RADIO HEAD
	RACEWAY SCHEDULE
SHT	SHEET
SIAD	SMART INTEGRATED ACCESS DEVICE
SIM	SIMILAR
SPEC	SPECIFICATION
SQ	SQUARE
SS STD	STAINLESS STEEL STANDARD
STL	STANDARD
TEMP	TEMPORARY
тнк	THICKNESS
ТМА	TOWER MOUNTED AMPLIFIER
TN	
TOA TOC	TOP OF ANTENNA TOP OF CURB
TOF	TOP OF CORD
TOP	TOP OF PLATE (PARAPET)
TOS	TOP OF STEEL
тоw	TOP OF WALL
TVSS	TRANSIENT VOLTAGE SURGE SUPPRESSION
TYP UG	TYPICAL UNDERGROUND
UG UL	UNDERGROUND UNDERWRITERS LABORATORY
UNO	UNLESS NOTED OTHERWISE
UMTS	UNIVERSAL MOBILE TELECOMMUNICATIONS SYSTEM
UPS	UNITERRUPTIBLE POWER SYSTEM (DC POWER PLANT)
VIF	VERIFIED IN FIELD
W	WIDE
W/	WITH
WD WP	WOOD WEATHERPROOF
wr≓ WT	WEIGHT

**ABBREVIATIONS** 



SIGN TYPES			
TYPE	COLOR	COLOR CODE PURPOSE	
NFORMATION	GREEN	"INFORMATIONAL SIGN" TO NOTIFY OTHERS OF SITE OWNERSHIP & CONTACT NUMBER AND POTENTIAL RF EXPOSURE.	
NOTICE	BLUE	"NOTICE BEYOND THIS POINT" RF FIELDS BEYOND THIS POINT MAY EXCEED THE FCC GENERAL PUBLIC EXPOSURE LIMIT. OBEY ALL POSTED SIGNS AND SITE GUIDELINES FOR WORKING IN RF ENVIRONMENTS. IN ACCORDANCE WITH FEDERAL COMMUNICATIONS COMMISSION RULES ON RADIO FREQUENCY EMISSIONS 47 CFR-1.1307(b)	
CAUTION	YELLOW	"CAUTION BEYOND THIS POINT" RF FIELDS BEYOND THIS POINT MAY EXCEED THE FCC GENERAL PUBLIC EXPOSURE LIMIT. OBEY ALL POSTED SIGNS AND SITE GUIDELINES FOR WORKING IN RF ENVIRONMENTS. IN ACCORDANCE WITH FEDERAL COMMUNICATIONS COMMISSION RULES ON RADIO FREQUENCY EMISSIONS 47 CFR-1.1307(b)	
WARNING	ORANGE/RED	"WARNING BEYOND THIS POINT" RF FIELDS AT THIS SITE EXCEED FCC RULES FOR HUMAN EXPOSURE. FAILURE TO OBEY ALL POSTED SIGNS AND SITE GUIDELINES FOR WORKING IN RF ENVIRONMENTS COULD RESULT IN SERIOUS INJURY. IN ACCORDANCE WITH FEDERAL COMMUNICATIONS COMMISSION RULES ON RADIO FREQUENCY EMISSIONS 47 CFR-1.1307(b)	

#### SIGN PLACEMENT:

- RF SIGNAGE PLACEMENT SHALL FOLLOW THE RECOMMENDATIONS OF AN EXISTING EME REPORT, CREATED BY A THIRD PARTY PREVIOUSLY AUTHORIZED BY DISH Wireless L.L.C.
- INFORMATION SIGN (GREEN) SHALL BE LOCATED ON EXISTING DISH Wireless L.L.C EQUIPMENT. A) IF THE INFORMATION SIGN IS A STICKER, IT SHALL BE PLACED ON EXISTING DISH Wireless L.L.C EQUIPMENT CABINET. B) IF THE INFORMATION SIGH IS A METAL SIGN IT SHALL BE PLACED ON EXISTING DISH Wireless L.L.C H-FRAME WITH A SECURE ATTACH METHOD.
- IF EME REPORT IS NOT AVAILABLE AT THE TIME OF CREATION OF CONSTRUCTION DOCUMENTS; PLEASE CONTACT DISH WIreless L.L.C. CONSTRUCTION MANAGER FOR FURTHER INSTRUCTION ON HOW TO PROCEED.

#### NOTES:

- 1. FOR DISH Wireless L.L.C. LOGO, SEE DISH Wireless L.L.C. DESIGN SPECIFICATIONS (PROVIDED BY DISH Wireless L.L.C.)
- 2. SITE ID SHALL BE APPLIED TO SIGNS USING "LASER ENGRAVING" OR ANY OTHER WEATHER RESISTANT METHOD (DISH Wireless L.L.C. APPROVAL REQUIRED)
- 3. TEXT FOR SIGNAGE SHALL INDICATE CORRECT SITE NAME AND NUMBER AS PER DISH Wireless L.L.C. CONSTRUCTION MANAGER RECOMMENDATIONS.
- 4. CABINET /SHELTER MOUNTING APPLICATION REQUIRES ANOTHER PLATE APPLIED TO THE FACE OF THE CABINET WITH WATER PROOF POLYURETHANE ADHESIVE
- IGNS WILL BE SECURED WITH EITHER STAINLESS STEEL ZIP TIES OR STAINLESS STEEL TECH SCREWS
- 6. ALL SIGNS TO BE 8.5"x11" AND MADE WITH 0.04" OF ALUMINUM MATERIAL

NOTICE

Radio frequency fields beyond this point MAY

**EXCEED the FCC Occupational exposure limit.** 

Obey all posted signs and site guidelines for

Call the DISH Wireless L.L.C. NOC at 1-866-624-6874

dish

working in radio frequency environments.

prior to working beyond this point.

Site ID:

Transmitting Antenna(s)

# INFORMAT

# This is an access point area with transmitting ar

Obey all signs and barriers beyond Call the DISH Wireless L.L.C. NOC at 1-

••••

Site ID:

THIS SIGN IS FOR REFERENCE PURPOSES ONLY



<u>RF SIGNAGE</u>

ION t to an	<b>DEST</b> WIRELESS 5701 SOUTH SANTA FE DRIVE LITTLETON, CO 80120
ntennas.	
his point. 866-624-6874	Fullerton-us.com
VING	IT IS A VIOLATION OF LAW FOR ANY PERSON, UNLESS THEY ARE ACTING UNDER THE DIRECTION OF A LICERNSED PROFESSIONAL ENGINEER, TO ALTER THIS DOCUMENT.
	DRAWN BY: CHECKED BY: APPROVED BY:
	LA DZ DS
	RFDS REV #: 1 PERMITTING DOCUMENTS
	SUBMITTALS
	REV DATE DESCRIPTION
	A         1/19/24         ISSUED FOR REVIEW           B         2/6/24         REVISION
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bint 방망 sure limit. :: ines for :: ents. :: 1-866-624-6874 ::	PROJECT INFORMATION CHCHI00890C
	715 LAKE ST.
<u>0</u> 75	OAK PARK, IL 60301
Si	
웉	SHEET TITLE RF
	SIGNAGE
	SHEET NUMBER
	GN-2

#### SITE ACTIVITY REQUIREMENTS:

1. NOTICE TO PROCEED - NO WORK SHALL COMMENCE PRIOR TO CONTRACTOR RECEIVING A WRITTEN NOTICE TO PROCEED (NTP) AND THE ISSUANCE OF A PURCHASE ORDER. PRIOR TO ACCESSING/ENTERING THE SITE YOU MUST CONTACT THE DISH Wireless L.L.C. AND TOWER OWNER NOC & THE DISH Wireless L.L.C. AND TOWER OWNER CONSTRUCTION MANAGER.

2. "LOOK UP" - DISH Wireless L.L.C. AND TOWER OWNER SAFETY CLIMB REQUIREMENT:

THE INTEGRITY OF THE SAFETY CLIMB AND ALL COMPONENTS OF THE CLIMBING FACILITY SHALL BE CONSIDERED DURING ALL STAGES OF DESIGN, INSTALLATION, AND INSPECTION. TOWER MODIFICATION, MOUNT REINFORCEMENTS, AND/OR EQUIPMENT INSTALLATIONS SHALL NOT COMPROMISE THE INTEGRITY OR FUNCTIONAL USE OF THE SAFETY CLIMB OR ANY COMPONENTS OF THE CLIMBING FACILITY ON THE STRUCTURE. THIS SHALL INCLUDE, BUT NOT BE LIMITED TO: PINCHING OF THE WIRE ROPE, BENDING OF THE WIRE ROPE FROM ITS SUPPORTS, DIRECT CONTACT OR CLOSE PROXIMITY TO THE WIRE ROPE WHICH MAY CAUSE FRICTIONAL WEAR, IMPACT TO THE ANCHORAGE POINTS IN ANY WAY, OR TO IMPEDE/BLOCK ITS INTENDED USE. ANY COMPROMISED SAFETY CLIMB, INCLUDING EXISTING CONDITIONS MUST BE TAGGED OUT AND REPORTED TO YOUR DISH WIRE SL.C. AND DISH WIRE SL.C. AND TOWER OWNER POC OR CALL THE NOC TO GENERATE A SAFETY CLIMB MAINTENANCE AND CONTRACTOR NOTICE TICKET.

3. PRIOR TO THE START OF CONSTRUCTION, ALL REQUIRED JURISDICTIONAL PERMITS SHALL BE OBTAINED. THIS INCLUDES, BUT IS NOT LIMITED TO, BUILDING, ELECTRICAL, MECHANICAL, FIRE, FLOOD ZONE, ENVIRONMENTAL, AND ZONING. AFTER ONSITE ACTIVITIES AND CONSTRUCTION ARE COMPLETED, ALL REQUIRED PERMITS SHALL BE SATISFIED AND CLOSED OUT ACCORDING TO LOCAL JURISDICTIONAL REQUIREMENTS.

4. ALL CONSTRUCTION MEANS AND METHODS; INCLUDING BUT NOT LIMITED TO, ERECTION PLANS, RIGGING PLANS, CLIMBING PLANS, AND RESCUE PLANS SHALL BE THE RESPONSIBILITY OF THE GENERAL CONTRACTOR RESPONSIBLE FOR THE EXECUTION OF THE WORK CONTAINED HEREIN, AND SHALL MEET ANSI/ASSE A10.48 (LATEST EDITION); FEDERAL, STATE, AND LOCAL REGULATIONS; AND ANY APPLICABLE INDUSTRY CONSENSUS STANDARDS RELATED TO THE CONSTRUCTION ACTIVITIES BEING PERFORMED. ALL RIGGING PLANS SHALL ADHERE TO ANSI/ASSE A10.48 (LATEST EDITION) AND DISH WIRELS L.L.C. AND TOWER OWNER STANDARDS, INCLUDING THE REQUIRED INVOLVEMENT OF A QUALIFIED ENGINEER FOR CLASS IV CONSTRUCTION, TO CERTIFY THE SUPPORTING STRUCTURE(S) IN ACCORDANCE WITH ANSI/TIA-322 (LATEST EDITION).

5. ALL SITE WORK TO COMPLY WITH DISH WIRELESS L.L.C. AND TOWER OWNER INSTALLATION STANDARDS FOR CONSTRUCTION ACTIVITIES ON DISH WIRELESS L.L.C. AND TOWER OWNER TOWER SITE AND LATEST VERSION OF ANSI/TIA-1019-A-2012 "STANDARD FOR INSTALLATION, ALTERATION, AND MAINTENANCE OF ANTENNA SUPPORTING STRUCTURES AND ANTENNAS."

6. IF THE SPECIFIED EQUIPMENT CAN NOT BE INSTALLED AS SHOWN ON THESE DRAWINGS, THE CONTRACTOR SHALL PROPOSE AN ALTERNATIVE INSTALLATION FOR APPROVAL BY DISH WIRELESS L.L.C. AND TOWER OWNER PRIOR TO PROCEEDING WITH ANY SUCH CHANGE OF INSTALLATION.

7. ALL MATERIALS FURNISHED AND INSTALLED SHALL BE IN STRICT ACCORDANCE WITH ALL APPLICABLE CODES, REGULATIONS AND ORDINANCES. CONTRACTOR SHALL ISSUE ALL APPROPRIATE NOTICES AND COMPLY WITH ALL LAWS, ORDINANCES, RULES, REGULATIONS AND LAWFUL ORDERS OF ANY PUBLIC AUTHORITY REGARDING THE PERFORMANCE OF THE WORK. ALL WORK CARRIED OUT SHALL COMPLY WITH ALL APPLICABLE MUNICIPAL AND UTILITY COMPANY SPECIFICATIONS AND LOCAL JURISDICTIONAL CODES, ORDINANCES AND APPLICABLE REGULATIONS.

8. THE CONTRACTOR SHALL INSTALL ALL EQUIPMENT AND MATERIALS IN ACCORDANCE WITH MANUFACTURER'S RECOMMENDATIONS UNLESS SPECIFICALLY STATED OTHERWISE.

9. THE CONTRACTOR SHALL CONTACT UTILITY LOCATING SERVICES INCLUDING PRIVATE LOCATES SERVICES PRIOR TO THE START OF CONSTRUCTION.

10. ALL EXISTING ACTIVE SEWER, WATER, GAS, ELECTRIC AND OTHER UTILITIES WHERE ENCOUNTERED IN THE WORK, SHALL BE PROTECTED AT ALL TIMES AND WHERE REQUIRED FOR THE PROPER EXECUTION OF THE WORK, SHALL BE RELOCATED AS DIRECTED BY CONTRACTOR. EXTREME CAUTION SHOULD BE USED BY THE CONTRACTOR WHEN EXCAVATING OR DRILLING PIERS AROUND OR NEAR UTILITIES. CONTRACTOR SHALL PROVIDE SAFETY TRAINING FOR THE WORKING CREW. THIS WILL INCLUDE BUT NOT BE LIMITED TO A) FALL PROTECTION B) CONFINED SPACE C) ELECTRICAL SAFETY D) TRENCHING AND EXCAVATION E) CONSTRUCTION SAFETY PROCEDURES.

11. ALL SITE WORK SHALL BE AS INDICATED ON THE STAMPED CONSTRUCTION DRAWINGS AND DISH PROJECT SPECIFICATIONS, LATEST APPROVED REVISION.

12. CONTRACTOR SHALL KEEP THE SITE FREE FROM ACCUMULATING WASTE MATERIAL, DEBRIS, AND TRASH AT THE COMPLETION OF THE WORK. IF NECESSARY, RUBBISH, STUMPS, DEBRIS, STICKS, STONES AND OTHER REFUSE SHALL BE REMOVED FROM THE SITE AND DISPOSED OF LEGALLY.

13. ALL EXISTING INACTIVE SEWER, WATER, GAS, ELECTRIC AND OTHER UTILITIES, WHICH INTERFERE WITH THE EXECUTION OF THE WORK, SHALL BE REMOVED AND/OR CAPPED, PLUGGED OR OTHERWISE DISCONTINUED AT POINTS WHICH WILL NOT INTERFERE WITH THE EXECUTION OF THE WORK, SUBJECT TO THE APPROVAL OF DISH WIRELESS L.L.C. AND TOWER OWNER, AND/OR LOCAL UTILITIES.

14. THE CONTRACTOR SHALL PROVIDE SITE SIGNAGE IN ACCORDANCE WITH THE TECHNICAL SPECIFICATION FOR SITE SIGNAGE REQUIRED BY LOCAL JURISDICTION AND SIGNAGE REQUIRED ON INDIVIDUAL PIECES OF EQUIPMENT, ROOMS, AND SHELTERS.

15. THE SITE SHALL BE GRADED TO CAUSE SURFACE WATER TO FLOW AWAY FROM THE CARRIER'S EQUIPMENT AND TOWER AREAS.

16. THE SUB GRADE SHALL BE COMPACTED AND BROUGHT TO A SMOOTH UNIFORM GRADE PRIOR TO FINISHED SURFACE APPLICATION.

17. THE AREAS OF THE OWNERS PROPERTY DISTURBED BY THE WORK AND NOT COVERED BY THE TOWER, EQUIPMENT OR DRIVEWAY, SHALL BE GRADED TO A UNIFORM SLOPE, AND STABILIZED TO PREVENT EROSION AS SPECIFIED ON THE CONSTRUCTION DRAWINGS AND/OR PROJECT SPECIFICATIONS.

18. CONTRACTOR SHALL MINIMIZE DISTURBANCE TO EXISTING SITE DURING CONSTRUCTION. EROSION CONTROL MEASURES, IF REQUIRED DURING CONSTRUCTION, SHALL BE IN CONFORMANCE WITH THE LOCAL GUIDELINES FOR EROSION AND SEDIMENT CONTROL.

19. THE CONTRACTOR SHALL PROTECT EXISTING IMPROVEMENTS, PAVEMENTS, CURBS, LANDSCAPING AND STRUCTURES. ANY DAMAGED PART SHALL BE REPAIRED AT CONTRACTOR'S EXPENSE TO THE SATISFACTION OF OWNER.

20. CONTRACTOR SHALL LEGALLY AND PROPERLY DISPOSE OF ALL SCRAP MATERIALS SUCH AS COAXIAL CABLES AND OTHER ITEMS REMOVED FROM THE EXISTING FACILITY. ANTENNAS AND RADIOS REMOVED SHALL BE RETURNED TO THE OWNER'S DESIGNATED LOCATION.

21. CONTRACTOR SHALL LEAVE PREMISES IN CLEAN CONDITION. TRASH AND DEBRIS SHOULD BE REMOVED FROM SITE ON A DAILY BASIS.

22. NO FILL OR EMBANKMENT MATERIAL SHALL BE PLACED ON FROZEN GROUND. FROZEN MATERIALS, SNOW OR ICE SHALL NOT

BE PLACED IN ANY FILL OR EMBANKMENT.

GENERAL NOTES:

1.FOR THE PURPOSE OF CONSTRUCTION DRAWING, THE FOLLOWING DEFINITIONS SHALL APPLY:

CONTRACTOR: GENERAL CONTRACTOR RESPONSIBLE FOR CONSTRUCTION

CARRIER: DISH Wireless L.L.C.

TOWER OWNER: TOWER OWNER

2. THESE DRAWINGS HAVE BEEN PREPARED USING STANDARDS OF PROFESSIONAL CARE AND COMPLETENESS NORMALLY EXERCISED UNDER SIMILAR CIRCUMSTANCES BY REPUTABLE ENGINEERS IN THIS OR SIMILAR LOCALITIES. IT IS ASSUMED THAT THE WORK DEPICTED WILL BE PERFORMED BY AN EXPERIENCED CONTRACTOR AND/OR WORKPEOPLE WHO HAVE A WORKING KNOWLEDGE OF THE APPLICABLE CODE STANDARDS AND REQUIREMENTS AND OF INDUSTRY ACCEPTED STANDARD GOOD PRACTICE. AS NOT EVERY CONDITION OR ELEMENT IS (OR CAN BE) EXPLICITLY SHOWN ON THESE DRAWINGS, THE CONTRACTOR SHALL USE INDUSTRY ACCEPTED STANDARD GOOD PRACTICE FOR MISCELLANEOUS WORK NOT EXPLICITLY SHOWN.

3. THESE DRAWINGS REPRESENT THE FINISHED STRUCTURE. THEY DO NOT INDICATE THE MEANS OR METHODS OF CONSTRUCTION. THE CONTRACTOR SHALL BE SOLELY RESPONSIBLE FOR THE CONSTRUCTION MEANS, METHODS, TECHNIQUES, SEQUENCES, AND PROCEDURES. THE CONTRACTOR SHALL PROVIDE ALL MEASURES NECESSARY FOR PROTECTION OF LIFE AND PROPERTY DURING CONSTRUCTION. SUCH MEASURES SHALL INCLUDE, BUT NOT BE LIMITED TO, BRACING, FORMWORK, SHORING, ETC. SITE VISITS BY THE ENGINEER OR HIS REPRESENTATIVE WILL NOT INCLUDE INSPECTION OF THESE ITEMS AND IS FOR STRUCTURAL OBSERVATION OF THE FINISHED STRUCTURE ONLY.

4. NOTES AND DETAILS IN THE CONSTRUCTION DRAWINGS SHALL TAKE PRECEDENCE OVER GENERAL NOTES AND TYPICAL DETAILS. WHERE NO DETAILS ARE SHOWN, CONSTRUCTION SHALL CONFORM TO SIMILAR WORK ON THE PROJECT, AND/OR AS PROVIDED FOR IN THE CONTRACT DOCUMENTS. WHERE DISCREPANCIES OCCUR BETWEEN PLANS, DETAILS, GENERAL NOTES, AND SPECIFICATIONS, THE GREATER, MORE STRICT REQUIREMENTS, SHALL GOVERN. IF FURTHER CLARIFICATION IS REQUIRED CONTACT THE ENGINEER OF RECORD.

5. SUBSTANTIAL EFFORT HAS BEEN MADE TO PROVIDE ACCURATE DIMENSIONS AND MEASUREMENTS ON THE DRAWINGS TO ASSIST IN THE FABRICATION AND/OR PLACEMENT OF CONSTRUCTION ELEMENTS BUT IT IS THE SOLE RESPONSIBILITY OF THE CONTRACTOR TO FIELD VERIFY THE DIMENSIONS, MEASUREMENTS, AND/OR CLEARANCES SHOWN IN THE CONSTRUCTION DRAWINGS PRIOR TO FABRICATION OR CUTTING OF ANY NEW OR EXISTING CONSTRUCTION ELEMENTS. IF IT IS DETERMINED THAT THERE ARE DISCREPANCIES AND/OR CONFLICTS WITH THE CONSTRUCTION DRAWINGS THE ENGINEER OF RECORD IS TO BE NOTIFIED AS SOON AS POSSIBLE.

6. PRIOR TO THE SUBMISSION OF BIDS, THE BIDDING CONTRACTOR SHALL VISIT THE CELL SITE TO FAMILIARIZE WITH THE EXISTING CONDITIONS AND TO CONFIRM THAT THE WORK CAN BE ACCOMPLISHED AS SHOWN ON THE CONSTRUCTION DRAWINGS. ANY DISCREPANCY FOUND SHALL BE BROUGHT TO THE ATTENTION OF CARRIER POC AND TOWER OWNER.

7. ALL MATERIALS FURNISHED AND INSTALLED SHALL BE IN STRICT ACCORDANCE WITH ALL APPLICABLE CODES, REGULATIONS AND ORDINANCES. CONTRACTOR SHALL ISSUE ALL APPROPRIATE NOTICES AND COMPLY WITH ALL LAWS, ORDINANCES, RULES, REGULATIONS AND LAWFUL ORDERS OF ANY PUBLIC AUTHORITY REGARDING THE PERFORMANCE OF THE WORK. ALL WORK CARRIED OUT SHALL COMPLY WITH ALL APPLICABLE MUNICIPAL AND UTILITY COMPANY SPECIFICATIONS AND LOCAL JURISDICTIONAL CODES, ORDINANCES AND APPLICABLE REGULATIONS.

8. UNLESS NOTED OTHERWISE, THE WORK SHALL INCLUDE FURNISHING MATERIALS, EQUIPMENT, APPURTENANCES AND LABOR NECESSARY TO COMPLETE ALL INSTALLATIONS AS INDICATED ON THE DRAWINGS.

9. THE CONTRACTOR SHALL INSTALL ALL EQUIPMENT AND MATERIALS IN ACCORDANCE WITH MANUFACTURER'S RECOMMENDATIONS UNLESS SPECIFICALLY STATED OTHERWISE.

10. IF THE SPECIFIED EQUIPMENT CAN NOT BE INSTALLED AS SHOWN ON THESE DRAWINGS, THE CONTRACTOR SHALL PROPOSE AN ALTERNATIVE INSTALLATION FOR APPROVAL BY THE CARRIER AND TOWER OWNER PRIOR TO PROCEEDING WITH ANY SUCH CHANGE OF INSTALLATION.

11. CONTRACTOR IS TO PERFORM A SITE INVESTIGATION, BEFORE SUBMITTING BIDS, TO DETERMINE THE BEST ROUTING OF ALL CONDUITS FOR POWER, AND TELCO AND FOR GROUNDING CABLES AS SHOWN IN THE POWER, TELCO, AND GROUNDING PLAN DRAWINGS.

12. THE CONTRACTOR SHALL PROTECT EXISTING IMPROVEMENTS, PAVEMENTS, CURBS, LANDSCAPING AND STRUCTURES. ANY DAMAGED PART SHALL BE REPAIRED AT CONTRACTOR'S EXPENSE TO THE SATISFACTION OF DISH Wireless L.L.C. AND TOWER OWNER

13. CONTRACTOR SHALL LEGALLY AND PROPERLY DISPOSE OF ALL SCRAP MATERIALS SUCH AS COAXIAL CABLES AND OTHER ITEMS REMOVED FROM THE EXISTING FACILITY. ANTENNAS REMOVED SHALL BE RETURNED TO THE OWNER'S DESIGNATED LOCATION.

14. CONTRACTOR SHALL LEAVE PREMISES IN CLEAN CONDITION. TRASH AND DEBRIS SHOULD BE REMOVED FROM SITE ON A DAILY BASIS.

DSCAPING AND STRUCTURES. ANY SH Wireless L.L.C. AND TOWER OWNER H AS COAXIAL CABLES AND OTHER HE OWNER'S DESIGNATED LOCATION.



5701 SOUTH SANTA FE DRIVE LITTLETON, CO 80120



I 100 E. WOODFIELD ROAD, SUITE 500 SCHAUMBURG, ILLINOIS 60173 TEL: 847-908-8400 DESIGN FIRM NO. 184.008202-0006 www.fullerton-us.com

IT IS A VIOLATION OF LAW FOR ANY PERSON, UNLESS THEY ARE ACTING UNDER THE DIRECTION OF A LICENSED PROFESSIONAL ENGINEER, TO ALTER THIS DOCUMENT.

DRAWN BY: CHECKED BY: APPROVED BY:

RFDS REV #

# PERMITTING DOCUMENTS

 SUBMITTALS

 REV
 DATE
 DESCRIPTION

 A
 1/19/24
 ISSUED FOR REVIEW

 B
 2/6/24
 REVISION

 O
 5/1/24
 ISSUED FOR PERMITTING

 1
 5/24/24
 REVISION

A&E PROJECT NUMBER 2023.0017.0072

DISH WIRELESS L.L.C. PROJECT INFORMATION CHCHI00890C 715 LAKE ST. OAK PARK, IL 60301

SHEET TITLE

GENERAL NOTES

SHEET NUMBER

GN-3

#### CONCRETE. FOUNDATIONS. AND REINFORCING STEEL:

ALL CONCRETE WORK SHALL BE IN ACCORDANCE WITH THE ACI 301, ACI 318, ACI 336, ASTM A184, ASTM A185 AND THE DESIGN AND CONSTRUCTION SPECIFICATION FOR CAST-IN-PLACE CONCRETE.

2 UNLESS NOTED OTHERWISE, SOIL BEARING PRESSURE USED FOR DESIGN OF SLABS AND FOUNDATIONS IS ASSUMED TO BE 1000 psf.

ALL CONCRETE SHALL HAVE A MINIMUM COMPRESSIVE STRENGTH (f'c) OF 3000 psi AT 28 DAYS, UNLESS NOTED OTHERWISE. NO 3. MORE THAN 90 MINUTES SHALL ELAPSE FROM BATCH TIME TO TIME OF PLACEMENT UNLESS APPROVED BY THE ENGINEER OF RECORD. TEMPERATURE OF CONCRETE SHALL NOT EXCEED 90'F AT TIME OF PLACEMENT.

CONCRETE EXPOSED TO FREEZE-THAW CYCLES SHALL CONTAIN AIR ENTRAINING ADMIXTURES. AMOUNT OF AIR ENTRAINMENT TO BE BASED ON SIZE OF AGGREGATE AND F3 CLASS EXPOSURE (VERY SEVERE). CEMENT USED TO BE TYPE II PORTLAND CEMENT WITH A MAXIMUM WATER-TO-CEMENT RATIO (W/C) OF 0.45.

ALL STEEL REINFORCING SHALL CONFORM TO ASTM A615. ALL WELDED WIRE FABRIC (WWF) SHALL CONFORM TO ASTM A185. ALL SPLICES SHALL BE CLASS "B" TENSION SPLICES, UNLESS NOTED OTHERWISE. ALL HOOKS SHALL BE STANDARD 90 DEGREE HOOKS, UNLESS NOTED OTHERWISE. YIELD STRENGTH (Fy) OF STANDARD DEFORMED BARS ARE AS FOLLOWS:

#### #4 BARS AND SMALLER 40 ksi

#5 BARS AND LARGER 60 ksi

THE FOLLOWING MINIMUM CONCRETE COVER SHALL BE PROVIDED FOR REINFORCING STEEL UNLESS SHOWN OTHERWISE ON DRAWINGS:

- CONCRETE CAST AGAINST AND PERMANENTLY EXPOSED TO EARTH 3"
- CONCRETE EXPOSED TO EARTH OR WEATHER:
- #6 BARS AND LARGER 2"
- #5 BARS AND SMALLER 1-1/2"
- · CONCRETE NOT EXPOSED TO EARTH OR WEATHER:
- SLAB AND WALLS 3/4"
- BEAMS AND COLUMNS 1-1/2"

A TOOLED EDGE OR A 3/4" CHAMFER SHALL BE PROVIDED AT ALL EXPOSED EDGES OF CONCRETE, UNLESS NOTED OTHERWISE, IN ACCORDANCE WITH ACI 301 SECTION 4.2.4.

#### **ELECTRICAL INSTALLATION NOTES:**

ALL ELECTRICAL WORK SHALL BE PERFORMED IN ACCORDANCE WITH THE PROJECT SPECIFICATIONS, NEC AND ALL APPLICABLE FEDERAL, STATE, AND LOCAL CODES/ORDINANCES.

CONDUIT ROUTINGS ARE SCHEMATIC. CONTRACTOR SHALL INSTALL CONDUITS SO THAT ACCESS TO EQUIPMENT IS NOT BLOCKED AND TRIP HAZARDS ARE ELIMINATED.

3. WIRING, RACEWAY AND SUPPORT METHODS AND MATERIALS SHALL COMPLY WITH THE REQUIREMENTS OF THE NEC.

ALL CIRCUITS SHALL BE SEGREGATED AND MAINTAIN MINIMUM CABLE SEPARATION AS REQUIRED BY THE NEC.

ALL EQUIPMENT SHALL BEAR THE UNDERWRITERS LABORATORIES LABEL OF APPROVAL, AND SHALL CONFORM TO REQUIREMENT OF THE NATIONAL ELECTRICAL CODE.

ALL OVERCURRENT DEVICES SHALL HAVE AN INTERRUPTING CURRENT RATING THAT SHALL BE GREATER THAN THE SHORT CIRCUIT CURRENT TO WHICH THEY ARE SUBJECTED, 22,000 AIC MINIMUM. VERIFY AVAILABLE SHORT CIRCUIT CURRENT DOES NOT EXCEED THE RATING OF ELECTRICAL EQUIPMENT IN ACCORDANCE WITH ARTICLE 110.24 NEC OR THE MOST CURRENT ADOPTED CODE PRE THE GOVERNING JURISDICTION.

EACH END OF EVERY POWER PHASE CONDUCTOR, GROUNDING CONDUCTOR, AND TELCO CONDUCTOR OR CABLE SHALL BE LABELED WITH COLOR-CODED INSULATION OR ELECTRICAL TAPE (3M BRAND, 1/2" PLASTIC ELECTRICAL TAPE WITH UV PROTECTION, OR EQUAL). THE IDENTIFICATION METHOD SHALL CONFORM WITH NEC AND OSHA.

ALL ELECTRICAL COMPONENTS SHALL BE CLEARLY LABELED WITH LAMICOID TAGS SHOWING THEIR RATED VOLTAGE, PHASE CONFIGURATION, WIRE CONFIGURATION, POWER OR AMPACITY RATING AND BRANCH CIRCUIT ID NUMBERS (i.e. PANEL BOARD AND CIRCUIT ID'S).

7. PANEL BOARDS (ID NUMBERS) SHALL BE CLEARLY LABELED WITH PLASTIC LABELS.

8 TIE WRAPS ARE NOT ALLOWED

ALL POWER AND EQUIPMENT GROUND WIRING IN TUBING OR CONDUIT SHALL BE SINGLE COPPER CONDUCTOR (#14 OR LARGER) 9 WITH TYPE THHW, THWN, THWN-2, XHHW, XHHW-2, THW, THW-2, RHW, OR RHW-2 INSULATION UNLESS OTHERWISE SPECIFIED.

SUPPLEMENTAL EQUIPMENT GROUND WIRING LOCATED INDOORS SHALL BE SINGLE COPPER CONDUCTOR (#6 OR LARGER) WITH 10 TYPE THHW, THWN, THWN-2, XHHW, XHHW-2, THW, THW-2, RHW, OR RHW-2 INSULATION UNLESS OTHERWISE SPECIFIED.

POWER AND CONTROL WIRING IN FLEXIBLE CORD SHALL BE MULTI-CONDUCTOR, TYPE SOOW CORD (#14 OR LARGER) UNLESS OTHERWISE SPECIFIED.

POWER AND CONTROL WIRING FOR USE IN CABLE TRAY SHALL BE MULTI-CONDUCTOR. TYPE TC CABLE (#14 OR LARGER), WITH 12. TYPE THHW, THWN, THWN-2, XHHW, XHHW-2, THW, THW-2, RHW, OR RHW-2 INSULATION UNLESS OTHERWISE SPECIFIED.

13 ALL POWER AND GROUNDING CONNECTIONS SHALL BE CRIMP-STYLE, COMPRESSION WIRE LUGS AND WIRE NUTS BY THOMAS AND BETTS (OR EQUAL). LUGS AND WIRE NUTS SHALL BE RATED FOR OPERATION NOT LESS THAN 75° C (90° C IF AVAILABLE).

14. RACEWAY AND CABLE TRAY SHALL BE LISTED OR LABELED FOR ELECTRICAL USE IN ACCORDANCE WITH NEMA, UL, ANSI/IEEE AND NEC.

15 ELECTRICAL METALLIC TUBING (EMT), INTERMEDIATE METAL CONDUIT (IMC), OR RIGID METAL CONDUIT (RMC) SHALL BE USED FOR EXPOSED INDOOR LOCATIONS.

ELECTRICAL METALLIC TUBING (EMT) OR METAL-CLAD CABLE (MC) SHALL BE USED FOR CONCEALED INDOOR LOCATIONS. 16.

SCHEDULE 40 PVC UNDERGROUND ON STRAIGHTS AND SCHEDULE 80 PVC FOR ALL ELBOWS/90s AND ALL APPROVED ABOVE 17 GRADE PVC CONDUIT.

LIQUID-TIGHT FLEXIBLE METALLIC CONDUIT (LIQUID-TITE FLEX) SHALL BE USED INDOORS AND OUTDOORS, WHERE VIBRATION OCCURS OR FLEXIBILITY IS NEEDED.

CONDUIT AND TUBING FITTINGS SHALL BE THREADED OR COMPRESSION-TYPE AND APPROVED FOR THE LOCATION USED. SET SCREW FITTINGS ARE NOT ACCEPTABLE.

CABINETS, BOXES AND WIRE WAYS SHALL BE LABELED FOR ELECTRICAL USE IN ACCORDANCE WITH NEMA, UL, ANSI/IEEE AND 20. THE NEC.

21 WREWAYS SHALL BE METAL WITH AN ENAMEL FINISH AND INCLUDE A HINGED COVER, DESIGNED TO SWING OPEN DOWNWARDS (WIREMOLD SPECMATE WIREWAY).

22. SLOTTED WIRING DUCT SHALL BE PVC AND INCLUDE COVER (PANDUIT TYPE E OR EQUAL).

23. CONDUITS SHALL BE FASTENED SECURELY IN PLACE WITH APPROVED NON-PERFORATED STRAPS AND HANGERS. EXPLOSIVE DEVICES (i.e. POWDER-ACTUATED) FOR ATTACHING HANGERS TO STRUCTURE WILL NOT BE PERMITTED. CLOSELY FOLLOW THE LINES OF THE STRUCTURE, MAINTAIN CLOSE PROXIMITY TO THE STRUCTURE AND KEEP CONDUITS IN TIGHT ENVELOPES. CHANGES IN DIRECTION TO ROUTE AROUND OBSTACLES SHALL BE MADE WITH CONDUIT OUTLET BODIES. CONDUIT SHALL BE INSTALLED IN A NEAT AND WORKMANLIKE MANNER. PARALLEL AND PERPENDICULAR TO STRUCTURE WALL AND CEILING LINES. ALL CONDUIT SHALL BE FISHED TO CLEAR OBSTRUCTIONS. ENDS OF CONDUITS SHALL BE TEMPORARILY CAPPED FLUSH TO FINISH GRADE TO PREVENT CONCRETE, PLASTER OR DIRT FROM ENTERING. CONDUITS SHALL BE RIGIDLY CLAMPED TO BOXES BY GALVANIZED MALLEABLE IRON BUSHING ON INSIDE AND GALVANIZED MALLEABLE IRON LOCKNUT ON OUTSIDE AND INSIDE.

EQUIPMENT CABINETS, TERMINAL BOXES, JUNCTION BOXES AND PULL BOXES SHALL BE GALVANIZED OR EPOXY-COATED SHEET 24. STEEL. SHALL MEET OR EXCEED UL 50 AND BE RATED NEMA 1 (OR BETTER) FOR INTERIOR LOCATIONS AND NEMA 3 (OR BETTER) FOR EXTERIOR LOCATIONS.


METAL RECEPTACLE, SWITCH AND DEVICE BOXES SHALL BE GALVANIZED, EPOXY-COATED OR NON-CORRODING; SHALL MEET OR 25. EXCEED UL 514A AND NEMA OS 1 AND BE RATED NEMA 1 (OR BETTER) FOR INTERIOR LOCATIONS AND WEATHER PROTECTED (WP OR BETTER) FOR EXTERIOR LOCATIONS.

NONMETALLIC RECEPTACLE, SWITCH AND DEVICE BOXES SHALL MEET OR EXCEED NEMA OS 2 (NEWEST REVISION) AND BE RATED 26 NEMA 1 (OR BETTER) FOR INTERIOR LOCATIONS AND WEATHER PROTECTED (WP OR BETTER) FOR EXTERIOR LOCATIONS.

THE CONTRACTOR SHALL NOTIFY AND OBTAIN NECESSARY AUTHORIZATION FROM THE CARRIER AND/OR DISH Wireless L.L.C. AND 27 TOWER OWNER BEFORE COMMENCING WORK ON THE AC POWER DISTRIBUTION PANELS.

28 THE CONTRACTOR SHALL PROVIDE NECESSARY TAGGING ON THE BREAKERS, CABLES AND DISTRIBUTION PANELS IN ACCORDANCE WITH THE APPLICABLE CODES AND STANDARDS TO SAFEGUARD LIFE AND PROPERTY.

- 29. INSTALL LAMICOID LABEL ON THE METER CENTER TO SHOW "DISH Wireless L.L.C.".
- ALL EMPTY/SPARE CONDUITS THAT ARE INSTALLED ARE TO HAVE A METERED MULE TAPE PULL CORD INSTALLED. 30.

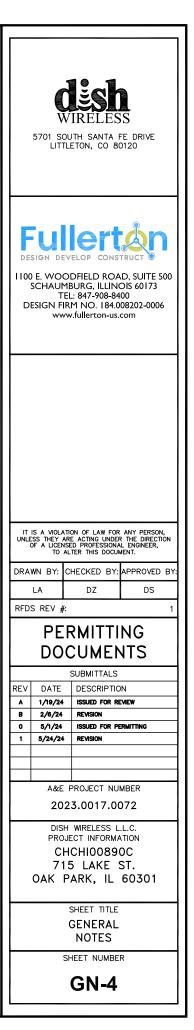

#### GROUNDING NOTES:

1. ALL GROUND ELECTRODE SYSTEMS (INCLUDING TELECOMMUNICATION, RADIO, LIGHTNING PROTECTION AND AC POWER GES'S) SHALL BE BONDED TOGETHER AT OR BELOW GRADE, BY TWO OR MORE COPPER BONDING CONDUCTORS IN ACCORDANCE WITH THE NEC.

2. THE CONTRACTOR SHALL PERFORM IEEE FALL-OF-POTENTIAL RESISTANCE TO EARTH TESTING (PER IEEE 1100 AND 81) FOR GROUND ELECTRODE SYSTEMS, THE CONTRACTOR SHALL FURNISH AND INSTALL SUPPLEMENTAL GROUND ELECTRODES AS NEEDED TO ACHIEVE A TEST RESULT OF 5 OHMS OR LESS.

3. THE CONTRACTOR IS RESPONSIBLE FOR PROPERLY SEQUENCING GROUNDING AND UNDERGROUND CONDUIT INSTALLATION AS TO PREVENT ANY LOSS OF CONTINUITY IN THE GROUNDING SYSTEM OR DAMAGE TO THE CONDUIT AND PROVIDE TESTING RESULTS.

4. METAL CONDUIT AND TRAY SHALL BE GROUNDED AND MADE ELECTRICALLY CONTINUOUS WITH LISTED BONDING FITTINGS OR BY BONDING ACROSS THE DISCONTINUITY WITH #6 COPPER WIRE UL APPROVED GROUNDING TYPE CONDUIT CLAMPS.

5. METAL RACEWAY SHALL NOT BE USED AS THE NEC REQUIRED EQUIPMENT GROUND CONDUCTOR. STRANDED COPPER CONDUCTORS WITH GREEN INSULATION, SIZED IN ACCORDANCE WITH THE NEC, SHALL BE FURNISHED AND INSTALLED WITH THE POWER CIRCUITS TO BTS EQUIPMENT.

6. EACH CABINET FRAME SHALL BE DIRECTLY CONNECTED TO THE MASTER GROUND BAR WITH GREEN INSULATED SUPPLEMENTAL EQUIPMENT GROUND WIRES, #6 STRANDED COPPER OR LARGER FOR INDOOR BTS; #2 BARE SOLID TINNED COPPER FOR OUTDOOR BTS.

7. CONNECTIONS TO THE GROUND BUS SHALL NOT BE DOUBLED UP OR STACKED BACK TO BACK CONNECTIONS ON OPPOSITE SIDE OF THE GROUND BUS ARE PERMITTED.

8. ALL EXTERIOR GROUND CONDUCTORS BETWEEN EQUIPMENT/GROUND BARS AND THE GROUND RING SHALL BE #2 SOLID TINNED COPPER UNLESS OTHERWISE INDICATED.

9. ALUMINUM CONDUCTOR OR COPPER CLAD STEEL CONDUCTOR SHALL NOT BE USED FOR GROUNDING CONNECTIONS.

10. USE OF 90' BENDS IN THE PROTECTION GROUNDING CONDUCTORS SHALL BE AVOIDED WHEN 45' BENDS CAN BE ADEQUATELY SUPPORTED.

11. EXOTHERMIC WELDS SHALL BE USED FOR ALL GROUNDING CONNECTIONS BELOW GRADE.

12. ALL GROUND CONNECTIONS ABOVE GRADE (INTERIOR AND EXTERIOR) SHALL BE FORMED USING HIGH PRESS CRIMPS.

13. COMPRESSION GROUND CONNECTIONS MAY BE REPLACED BY EXOTHERMIC WELD CONNECTIONS.

14. ICE BRIDGE BONDING CONDUCTORS SHALL BE EXOTHERMICALLY BONDED OR BOLTED TO THE BRIDGE AND THE TOWER GROUND BAR.

15. APPROVED ANTIOXIDANT COATINGS (i.e. CONDUCTIVE GEL OR PASTE) SHALL BE USED ON ALL COMPRESSION AND BOLTED GROUND CONNECTIONS.

16. ALL EXTERIOR GROUND CONNECTIONS SHALL BE COATED WITH A CORROSION RESISTANT MATERIAL.


17. MISCELLANEOUS ELECTRICAL AND NON-ELECTRICAL METAL BOXES, FRAMES AND SUPPORTS SHALL BE BONDED TO THE GROUND RING, IN ACCORDANCE WITH THE NEC.

18. BOND ALL METALLIC OBJECTS WITHIN 6 ft OF MAIN GROUND RING WITH (1) #2 BARE SOLID TINNED COPPER GROUND CONDUCTOR.

19. GROUND CONDUCTORS USED FOR THE FACILITY GROUNDING AND LIGHTNING PROTECTION SYSTEMS SHALL NOT BE ROUTED THROUGH METALLIC OBJECTS THAT FORM A RING AROUND THE CONDUCTOR, SUCH AS METALLIC CONDUITS, METAL SUPPORT CLIPS OR SLEEVES THROUGH WALLS OR FLOORS. WHEN IT IS REQUIRED TO BE HOUSED IN CONDUIT TO MEET CODE REQUIREMENTS OR LOCAL CONDITIONS, NON-METALLIC MATERIAL SUCH AS PVC CONDUIT SHALL BE USED. WHERE USE OF METAL CONDUIT IS UNAVOIDABLE (i.e., NONMETALLIC CONDUIT PROHIBITED BY LOCAL CODE) THE GROUND CONDUCTOR SHALL BE BONDED TO EACH END OF THE METAL CONDUIT.

20. ALL GROUNDS THAT TRANSITION FROM BELOW GRADE TO ABOVE GRADE MUST BE #2 BARE SOLID TINNED COPPER IN 3/4" NON-METALLIC, FLEXIBLE CONDUIT FROM 24" BELOW GRADE TO WITHIN 3" TO 6" OF CAD-WELD TERMINATION POINT. THE EXPOSED END OF THE CONDUIT MUST BE SEALED WITH SILICONE CAULK. (ADD TRANSITIONING GROUND STANDARD DETAIL AS WELL).

21. BUILDINGS WHERE THE MAIN GROUNDING CONDUCTORS ARE REQUIRED TO BE ROUTED TO GRADE, THE CONTRACTOR SHALL ROUTE TWO GROUNDING CONDUCTORS FROM THE ROOFTOP, TOWERS, AND WATER TOWERS GROUNDING RING, TO THE EXISTING GROUNDING SYSTEM, THE GROUNDING CONDUCTORS SHALL NOT BE SMALLER THAN 2/0 COPPER. ROOFTOP GROUNDING RING SHALL BE BONDED TO THE EXISTING GROUNDING SYSTEM, THE BUILDING STEEL COLUMNS, LIGHTNING PROTECTION SYSTEM, AND BUILDING MAIN WATER LINE (FERROUS OR NONFERROUS METAL PIPING ONLY). DO NOT ATTACH GROUNDING TO FIRE SPRINKLER SYSTEM PIPES.

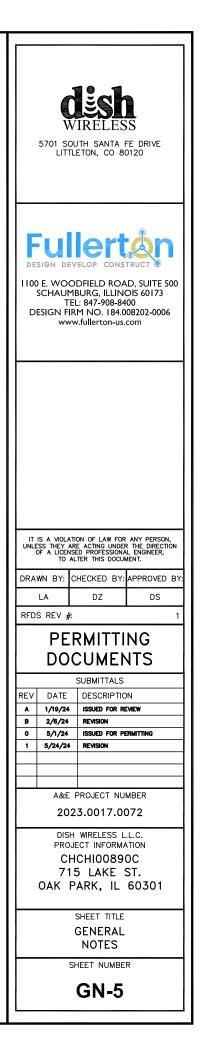

#### STRUCTURAL NOTES:

#### APPLICABLE CODES

1. DESIGN & CONSTRUCTION OF ALL WORK SHALL CONFORM TO THE FOLLOW CODES:

2021 INTERNATIONAL BUILDING

#### DESIGN LOADS:

WIND LOAD:

107 MPH ULTIMATE DESIGN WIND SPEED

SEISMIC LOAD:

#### MANDATORY SUBMITTALS:

- 1. THE FOLLOWING PRE CONSTRUCTION ITEMS SHALL BE SUBMITTED BY THE CONTRACTOR FOR REVIEW AND APPROVAL TO THE ENGINEER 4. OF RECORD TO ORDERING OR FABRICATION OF ANY MATERIAL.
  - STRUCTURAL STEEL SHOP DRAWINGS

GENERAL NOTES

- 1. THE CONTRACTOR SHALL BE RESPONSIBLE FOR FOLLOWING ALL LAWS, REGULATIONS, AND RULES SET FORTH BY FEDERAL, STATE, AND LOCAL AUTHORITIES WITH JURISDICTION OVER THE PROJECT. THIS RESPONSIBILITY IS IN EFFECT REGARDLESS OF WHETHER THE LAW, ORDINANCE, REGULATION OR RULE IS MENTIONED IN THESE SPECIFICATIONS.
- 2. ALL WORK SHALL BE COMPLETED AS INDICATED ON THE DRAWINGS, PROJECT SPECIFICATIONS, AND THE CONSTRUCTION CONTRACT DOCUMENTS.
- 3. THE CONTRACTOR SHALL HAVE AND MAINTAIN A VALID CONTRACTOR'S LICENSE FOR THE LOCATION IN WHICH THE WORK IS TO BE PERFORMED. FOR JURISDICTIONS THAT LICENSE INDIVIDUAL TRADES, THE TRADESMAN OR SUBCONTRACTOR PERFORMING THOSE TRADES SHALL BE LICENSED.
- 4. FOLLOW ALL APPLICABLE RULES AND REGULATIONS OF THE OCCUPATIONAL SAFETY AND HEALTH ADMINISTRATION (OSHA) AND STATE LAW AS DEFINED IN THE FEDERAL OCCUPATIONAL SAFETY AND HEALTH ACT.
- 5. PRIOR TO THE SUBMISSION OF THE BID, THE CONTRACTOR SHALL VISIT THE JOB SITE, VERIFY ALL DIMENSIONS AND BECOME FAMILIAR WITH THE FIELD CONDITIONS. ANY DISCREPANCIES SHALL BE BROUGHT TO THE ATTENTION OF THE PROJECT MANAGER.
- 6. DRAWING PLANS SHALL NOT BE SCALED.
- 7. THE CONTRACTOR SHALL NOT PROCEED WITH ANY WORK NOT CLEARLY IDENTIFIED ON THE DRAWINGS WITHOUT THE PRIOR WRITTEN APPROVAL OF THE PROJECT MANAGER.
- 8. THE CONTRACTOR SHALL INSTALL ALL EQUIPMENT AND MATERIALS IN ACCORDANCE WITH MANUFACTURER RECOMMENDATIONS UNLESS SPECIFICALLY OTHERWISE NOTED.
- 9. ALL MEANS AND METHODS OF CONSTRUCTION DEALING WITH TOWER CONSTRUCTION AND SAFETY, STEEL ERECTION, EXCAVATIONS, TRENCHING, SCAFFOLDING, FORMWORK, ELECTRICAL, AND WORK IN CONFINED SPACES ARE THE SOLE RESPONSIBILITY OF THE CONTRACTOR.
- 10. THE CONTRACTOR SHALL BE RESPONSIBLE FOR INITIATING, MAINTAINING, AND SUPERVISING ALL SAFETY PRECAUTIONS AND PROGRAMS IN CONNECTION WITH THE WORK.
- 11. THE CONTRACTOR SHALL BE EXPERIENCED IN THE PERFORMANCE OF WORK SIMILAR TO THAT DESCRIBED HEREIN. BY ACCEPTANCE OF THIS ASSIGNMENT, THE CONTRACTOR IS ATTESTING THAT HE DOES HAVE SUFFICIENT EXPERIENCE AND ABILITY AND THAT HE IS KNOWLEDGEABLE OF THE WORK TO BE PERFORMED.
- 12. THE CONTRACTOR SHALL PROVIDE SUFFICIENT TEMPORARY BRACING AND/OR SHORING OF ALL STRUCTURAL AND NON-STRUCTURAL ELEMENTS DURING CONSTRUCTION UNTIL ALL STRUCTURAL ELEMENTS HAVE BEEN PROPERLY INSTALLED.
- 13. INCORRECTLY FABRICATED, DAMAGED, OR OTHERWISE MISFITTING OR NONCONFORMING MATERIALS SHALL BE REPORTED TO THE PROJECT MANAGER AND ENGINEER, AND SHALL REQUIRE APPROVAL PRIOR TO PERFORMING ANY REMEDIAL OR CORRECTIVE ACTION.


#### STRUCTURAL STEEL NOTES:


- STRUCTURAL STEEL MATERIALS CONFORM TO THE LATEST EDITION OF APPLICABLE STANDARDS AND TO ALL APPLICABLE CODES AND REQUIREMENTS OF LOCAL AUTHORITIES HAVING JURISDICTION, WHICHEVER IS MORE STRINGENT. ALL STRUCTURAL STEEL SHALL BE IN ACCORDANCE WITH THE LATEST APPLICABLE REQUIREMENTS OF AISC, ASTM, ACI, CRSI, AWS AND ALL OTHER APPLICABLE STANDARDS
- ALL NEW STRUCTURAL STEEL SHALL CONFORM TO THE FOLLOWING, UNLESS NOTED OTHERWISE ON THE DRAWINGS: ASTM A36 (Fy = 36 KSI) M-SHAPES, S-SHAPES, ANGLES,
  - PLATES (U.N.O.) ASTM A992 (Fy = 50 KSI) W-SHAPES, CHANNELS (U.N.O.) ASTM A500 Gr C (Fy = 50 KSI) ROUND AND SQUARE HSS
- 3. STEEL PIPE SHALL COMPLY WITH ASTM A53 GRADE B. MAY BE SUBSTITUTED WITH ASTM 500 GRADE C (ROUND HSS)
- ALL STRUCTURAL STEEL, UNISTRUT, AND ALL SUPPORTING STEEL MEMBERS SHALL BE HOT DIPPED GALVANIZED IN ACCORDANCE WITH ASTM A153 AND A123, INCLUDING CONNECTION HARDWARE (BOLTS, WASHERS, NUTS, AND PINS), PLATES, SPACERS, AND FILLERS.
- 5. CONNECTIONS:
  - A. CONTRACTOR SHALL PROVIDE ALL HARDWARE REQUIRED TO COMPLETE FIELD ERECTION OF STRUCTURE AS INDICATED BY CONTRACT DOCUMENTS OR THESE SPECIFICATIONS.
  - B. HIGH STRENGTH THREADED FASTENERS SHALL BE INSTALLED IN ACCORDANCE WITH THE RESEARCH COUNCIL ON STRUCTURAL CONNECTIONS (RCSC) SPECIFICATION FOR STRUCTURAL JOINTS USING ASTM A325 OR A490 BOLTS. USE A-325N BEARING-TYPE CONNECTION BOLTS UNLESS NOTED OTHERWISE.
  - C. GRATING AND PLATES SHALL BE FASTENED WITH SADDLE CLIPS. THE NECESSARY HOLES TO COMPLETE ALL PHASES OF CONSTRUCTION SHALL BE PROVIDED AND CALLED OUT ON THE APPROVED SHOP DRAWINGS. ALL HOLES SHALL BE DRILLED OR PUNCHED PERPENDICULAR TO METAL SURFACES, FLAME CUT OR BURNED HOLES WILL NOT BE PERMITTED.
  - D. ALL UNFINISHED THREADED FASTENERS SHALL COMPLY WITH ASTM A-307, GRADE A, REGULAR LOW-CARBON STEEL BOLTS AND NUTS WITH HEXAGONAL HEADS IN ACCORDANCE WITH ASTM SPECIFICATION A563.
  - E. ALL HIGH STRENGTH THREADED FASTENERS SHALL BE HEAVY HEXAGONAL BOLTS AND NUTS WITH HARDENED WASHERS, ALL FROM QUENCHED AND TEMPERED MEDIUM CARBON STEEL COMPLYING WITH ASTM A-325.


#### GENERAL WELDING

<u>NOTES</u>

- 1. ALL WELDING SHALL BE IN ACCORDANCE WITH AWWA D100 SEC. 8, WELDING, SEC. 10, ERECTION AND SEC. 11, INSPECTION AND TESTING.
- 2. UNLESS NOTED OTHERWISE ALL WELDS TO THE TANK SURFACE SHALL BE MADE WITH E7018 LOW HYDROGEN ROD AND SHALL BE SMOOTH AND FREE OF BURRS AND UNDERCUTS. UNACCEPTABLE WELDS SHALL BE REPAIRED AS REQUIRED TO MEET AWWA D100 REQUIREMENTS.
- NO WELDING SHALL BE DONE WHEN THE AMBIENT TEMPERATURE IS BELOW 32 DEGREE FAHRENHEIT UNLESS THE REQUIREMENTS OF AWWA D100, SEC 10.2.1 ARE FOLLOWED.
- 4. WELDING MAY CAUSE BLISTERING OF THE INTERIOR PAINT OPPOSITE THE WELD. DAMAGED PAINT SURFACES SHOULD BE REPAIRED PER WATER TANK OWNER SPECIFICATIONS. CONTRACTOR SHALL COORDINATE ALL PAINT MATERIALS & METHODS WITH OWNER PRIOR TO WORK BEING DONE.
- 5. GALVANIZED COMPONENTS SHALL NOT BE WELDED DIRECTLY TO THE TANK SURFACE.
- 6. ALL WELDS IN THE TANK AND STRUCTURAL ATTACHMENTS SHALL BE MADE IN A MANNER TO ENSURE COMPLETE FUSION WITH THE BASE METAL, WITHIN THE LIMITS SPECIFIED FOR EACH JOINT, AND IN STRICT ACCORDANCE WITH THE QUALIFIED WELDING PROCEDURE SPECIFICATIONS.
- 7. UNLESS NOTED OTHERWISE ALL WELDS FOR ANTENNA INSTALLATION SHALL BE SEAL WELDS.

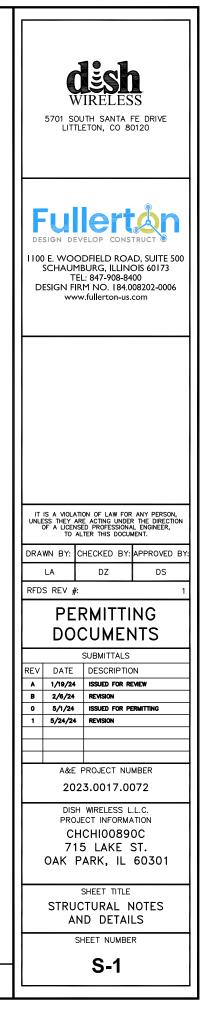

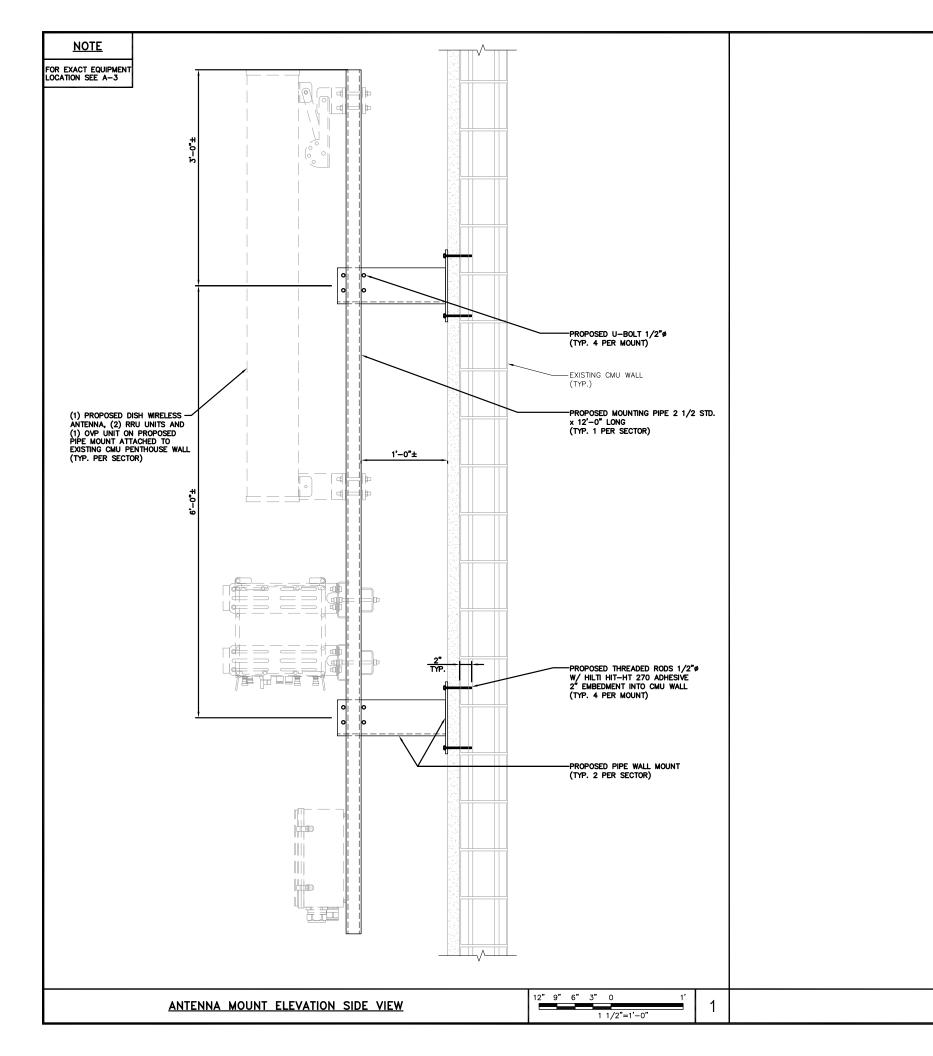


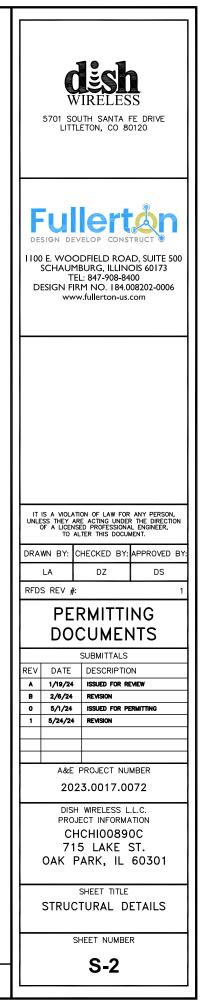


#### <u>NOTES</u>

FOR EXACT EQUIPMENT LOCATION SEE A-2

CONTRACTOR TO VERIFY EXACT LOCATION AND SIZE OF EXISTING CONNECTION BELOW STEEL PLATFORM PRIOR TO CONSTRUCTION

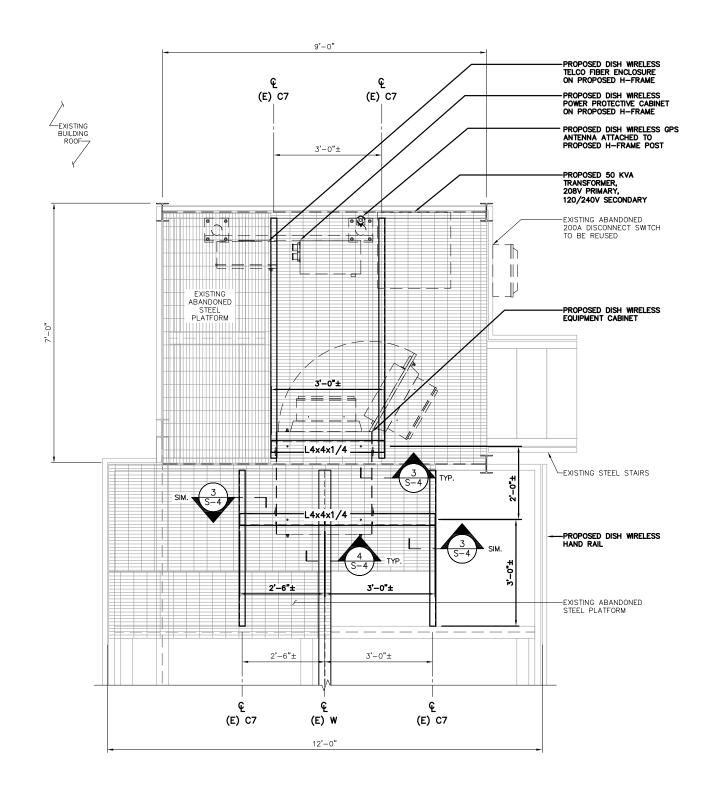

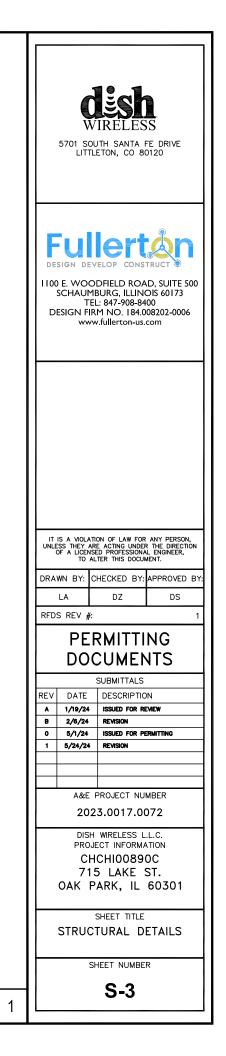

12"6"0

1'

3/4"=1'-0"

3'

2'

