

# Application for Public Hearing SPECIAL USE PERMIS

YOU MUST PROVIDE THE FOLLOWING INFORMATION: IF ADDITIONAL SPACE IS NEEDED, ATTACH EXTRA PAGES TO THE PETITION.

Name of Business (If applicable):Journey's Community Center, Inc
Address/Location of Property in Question: 6632 Roosevelt Rd, Oak Park, IL 60304
Property Identification Number(s)(PIN): 16-18-424-037-0000
Name of Property Owner(s): Journey's Community Center, Inc, Kate Harbert & Luis E Lopez
Address of Property Owner(s): 4939 West Fullerton Ave, Chicago, IL 60639
kateharbert@journeyscommunity.com  E-Mail of Property Owner(s): luislopez@journeyscommunity.com Phone: 708-683-9725
If Land Trust, name(s) of all beneficial owners: (A Certificate of Trust must be filed.)
Name of Applicant(s): Journey's Community Center, Inc, Kate Harbert & Luis E Lopez
Applicant's Address: 4939 West Fullerton Ave, Chicago, IL 60639
• •
Applicant's Phone Number: 708-683-9725E-Mail kateharbert@journeyscommunity.com luislopez@journeyscommunity.com  Other:
Project Contact: (if Different than Applicant)
Contact's Address:E-Mail
Other:
Property Interest of Applicant: X Owner Legal Representative Contract Purchaser Other  (If Other - Describe):
Existing Zoning: RR District Describe Proposal: We request the approval of a special use permit for the purpose of Mental Health Outpatient services, currently classified as a Medical/Dental Clinic by Oak Park
Zoning Ordinance. The building will be utilized by Journey's Community Center, a single-tenant occupant,
for both Administrative work and in-person psychotherapy services.

Size of Pa	rcel (from Plat of Survey): _	6250 Square Feet
Adjacent:	Zoning Districts	Land Uses
	orth: <u>R-4</u>	Single Family
	outh: _ Berwyn	C-2 Mixed Use Commercial
	st: RR District	Dental Clinic
	est: RR District	Dry Cleaners
How the p	roperty in question is curr	ently improved?
	I Residential ☐ Non-Res	dential ☐ Mixed Use 🗷 OTHER: RR District
	escribe improvement.	
_		
		in violation of the Zoning Ordinance?Yes _XNo
9 1	700, 110W :	
		subject to a Special Use Permit?YesX_No
		Ordinance No.'s
Is the sub	ect property located withir	any Historic District? Yes X No
		t □ Ridgeland/Oak Park ☑ Gunderson
	, 0	
From what	Section(s) of the Zoning C	rdinance are you requesting approval / relief?
Article:	5.4	Section:K - Uses
Article:		Section:
		Section:
contrary to t	he intent and purpose of the	of this request will be in harmony with the neighborhood and not be Zoning Ordinance or Comprehensive Plan;   commercial zone area. There are nearby medical/dental clinics alread
		nic aligns with RR District purpose of promiting a building design and a
		trian friendly and accessible while still allowing for adequate parking.
		5 quantity
		, and the same same and the same parking.

I (we) certify that all the above statements and the statements contained in any papers or plans submitted herewith are true to the best of my (our) knowledge and belief.

I (we) consent to the entry in or upon the premises described in this application by any authorized official of the Village of Oak Park for the purpose of securing information, posting, maintaining and removing such notices as may be required by law.

Kate Harbert & Luis E Lopez

(Printed Name) Applicant

)(ati) 18/a

6 6 2024 Date

x Luis & Lopez

Kate Harbert & Luis E Lopez

(Printed Name) Owner

(Fillited Name) Owner

(Signature) Owner

61612024

#### Owner's Signature must be notarized

SUBSCRIBED AND SWORN TO BEFORE ME THIS

6 DAY OF Thre 2,92

(Notary Public)

Official Seal
TAMMIKA S LEE
Notary Public, State of Illinois
Commission No. 987179
My Commission Expires February 16, 2028

Updated August 2021

#### **Project Summary:**

Journey's Community Center is a registered not-for-profit 501(c)(3) organization recognized by the Internal Revenue Service and the State of Illinois. Journey's Community Center operates as a charitable organization and functions as a non-medical outpatient mental health agency. The property at 6632-6634 Roosevelt Road was previously utilized by split tenants, including a first-floor retail shop and a second-floor office space that housed "Housing Forward." The property remained vacant from 2018 until 2023 when Journey's Community Center acquired the site. Currently, the site has an approved occupancy designation for Corporate Office and Administrative Work use. The sixty-five-hundred-square-foot building is a two-story structure with a maximum occupancy of seventy-five individuals. Since its acquisition by Journey's Community Center in December 2023, the property has undergone renovations to upgrade structural, mechanical, and safety systems to comply with the most up-to-date Village ordinance and building codes.

Journey's Community Center requests a special use permit to expand the site to include non-medical outpatient psychotherapy services and small group mental health workshops that do not exceed the approved occupancy criteria. Although Journey's Community Center is not a medical practice, psychotherapy services are classified by the Oak Park Zoning Ordinance, Article 2.3, as a Medical/Dental Clinic.

#### Special Use Approval Standards: Section 14.2 (E)

The recommendation of the Zoning Board of Appeals and decision of the Village Board must make findings to support each of the following conclusions:

1. The establishment, maintenance, and operation of the proposed special use will not endanger the public health, safety, or welfare.

The 6632-6634 Roosevelt Road property has been updated to meet Oak Park building codes and ordinances. To ensure public health, safety, and welfare, the facility undergoes regular maintenance, including fire alarm system checks and adherence to safety protocols. As a mental health agency, Journeys does not produce, sell, or distribute hazardous materials, nor does it create unsanitary conditions or other health hazards. The occupancy limit is set to fewer than 75 individuals, mitigating risks related to traffic, fire hazards, and unsafe building conditions. Additionally, our non-medical services do not contribute to noise pollution, environmental degradation, or other nuisances, maintaining the quality of life for residents.

2. The proposed special use is compatible with the general land use of adjacent properties and other property within the immediate vicinity.

The property at 6632-6634 West Roosevelt Ave, Oak Park, Illinois, built in 1921, has historically served various commercial purposes, including retail and office space. Within a 300-foot radius, several small businesses operate, including a dentist's office, dry cleaners, vehicle oil change company, bank, and restaurants. The proposed use of the building aligns with the existing uses and character of the surrounding area. The architectural style and design are consistent with neighboring properties, and Journeys' operations (Monday to Saturday, 9 am to 8 pm) do not disrupt adjacent businesses or traffic. The site includes private parking with seven spaces, including one accessible space. No exterior alterations are planned that would affect pedestrian or vehicular traffic flow.


3. The special use in the specific location is consistent with the spirit and intent of this Ordinance and adopted land use policies.


The proposed special use permit request aligns with the overall goals and purposes of the zoning ordinance by promoting orderly development, protecting the health and safety of residents, and enhancing the quality of life in the community. The Roosevelt Road district is zoned for business and commercial usage. The RR-T District is intended to promote pedestrian-friendly and accessible building design and site planning while ensuring adequate parking. Additionally, this request aligns with two key priority areas identified in Oak Park's Public Health Department's 2022 Community Needs Assessment Goals: increasing awareness of mental wellness and ensuring access to equitable care.

4. The special use conforms to the regulations of the zoning district in which it is to be located.

6632 Roosevelt Rd TMPPL20240000353

The property at 6632-6634 West Roosevelt Ave, Oak Park, Illinois, conforms with the zoning district regulations as a Medical/Dental clinic. According to the current zoning ordinance, Medical/Dental Clinics are permitted in the Roosevelt Road District upon approval of a special use permit.

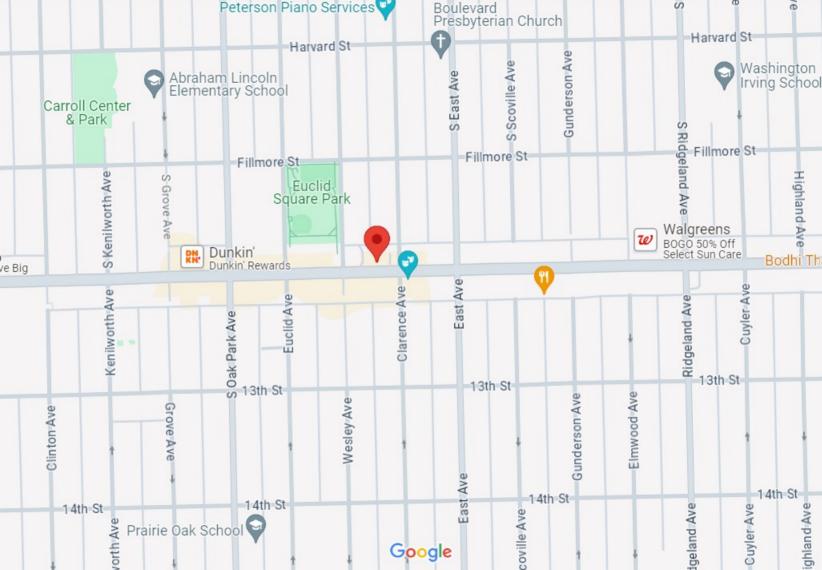

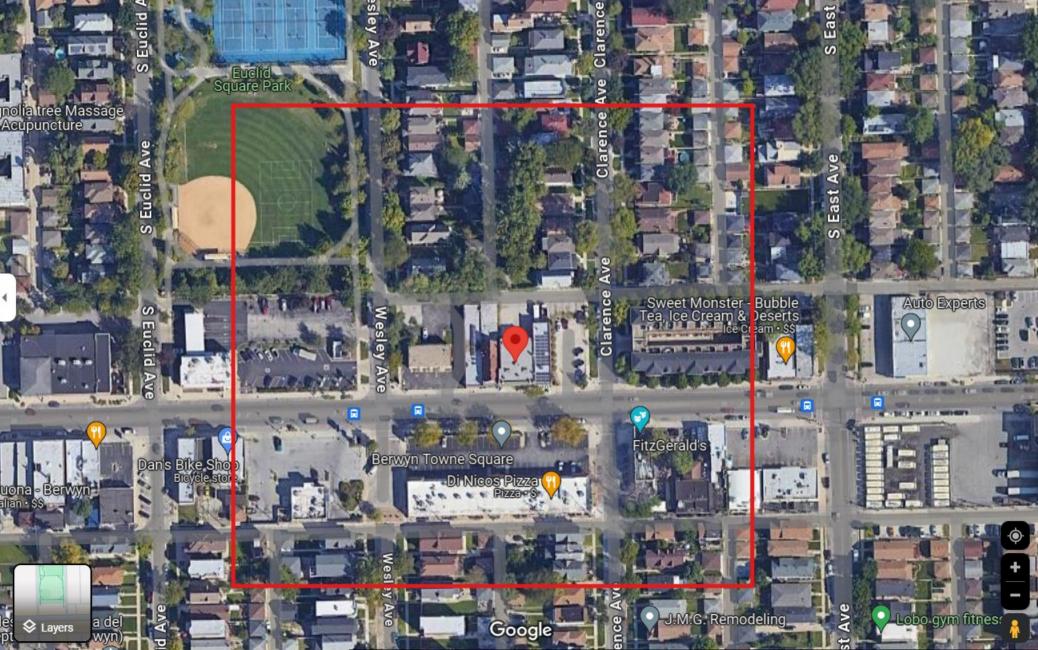

ISSUED FOR PERMIT - DECEMBER 20th. 2023

#### GENERAL NOTES:

1. ALL WORK SHALL CONFORM TO CODES OF VILLAGE OF OAK PARK AT THE TIME OF PERMIT AND CONSTRUCTION.

2. ALL INTERIOR DIMENSIONS ARE TO THE ROUGH FACE OF THE WALL, UNLESS OTHERWISE NOTED.

3. THE CONTRACTOR SHALL VERIFY IN FIELD ALL DIMENSIONS, ANGLES AND EXISTING CONDITIONS BEFORE PROCEEDING WITH ANY

4. VARIATIONS IN THE FIELD CONDITIONS RELATIVE TO THE CONTRACT DOCUMENTS SHALL BE REPORTED TO THE ARCHITECT IN WRITTEN. WORK SHALL NOT PROGRESS UNTIL CLARIFICATION FROM THE ARCHITECT IS OBTAINED.

5. ALL DEBRIS RESULTING FROM CONSTRUCTION OPERATIONS BY INDIVIDUAL SUB-CONTRACTORS SHALL BE REMOVED FROM THE BUILDING AND ADJOINING PROPERTY ON A DAILY BASIS.

6. ALL WORK SHALL BE ERECTED PLUMB, LEVEL AND TRUE AND IN ACCORDANCE WITH DETAILS. EXCESSIVELY SCUFFED, SCRATCHED, DENTED OR OTHERWISE DAMAGED FINISHED SURFACES MUST BE REPAIRED OR REPLACED AS DIRECTED BY OWNER.

9. DO NOT SCALE DRAWINGS, LARGE SCALE DRAWINGS AND DETAILS GOVERN OVER SMALLER SCALE DRAWINGS.

10. FLASHING TO BE PROVIDED AT ALL ROOF PENETRATIONS SHALL BE INSTALLED IN SUCH A MANNER TO BE LEAK PROOF.

11. SMOKING IS PROHIBITED IN BUILDING OR ON SITE EXCEPT FOR DESIGNATED SMOKING AREAS.

12. ALL NAILS, SCREWS, ETC. SHOULD BE SECURED DAILY.

13. ALL PERMIT FEES OR BUSINESS LICENSES TO BE PAID BY RESPECTIVE SUB-CONTRACTORS.

14. OWNER SHALL PAY THE GENERAL BUILDING PERMIT FEE.

15. THE GENERAL CONTRACTOR SHALL PROVIDE A "PORT-A-JOHN" FOR USE DURING THE DURATION OF CONSTRUCTION. THE LOCATION SHALL BE APPROVED BY THE OWNER.

16. "ABC" FIRE EXTINGUISHERS TO BE VISIBLE & ACCESSIBLE WHERE REQUIRED.

17. THE SUB-CONTRACTORS SHALL NOTIFY THE OWNER IF DRIVEWAY, ELECTRICAL POWER OR PLUMBING SUPPLIES WILL BE OUT OF SERVICE FOR A PERIOD GREATER THAN SIX HOURS. THIS NOTICE SHOULD BE GIVEN 24 HOURS IN ADVANCE.

18. ALL INTERIOR FINISHES TO MEET CLASS 1 FLAME SPREAD (0-25 FLAME SPREAD RATING)

19. ALL EXIT DOORS TO BE KEYLESS IN THE DIRECTION OF EXIT.

20. ALL CONTRACTORS, SUB-CONTRACTORS, AND SUPPLIERS MUST HAUL AWAY A GARBAGE, DEBRIS, AND SCRAPS RESULTING FROM THEIR WORK AT THE SITE. THE ABOVE MUST BE SWEPT UP AT THE END OF EACH DAY AND HAULED AWAY. NO DEBRIS SHALL BE PLACED FOR REMOVAL BY THE OWNERS SITE GARBAGE COLLECTION SERVICE. ANY DEBRIS LEFT BY CONTRACTORS, SUB-CONTRACTORS, OR SUPPLIERS SHALL HAULED AWAY AT THEIR EXPENSE.

21. ROUGH CARPENTER TO PROVIDE 2X12 BLOCKING AT ALL RESTROOM ACCESSORY LOCATIONS, ACCESSIBILITY HANDRAIL

22. ALL FINISH WOOD FLOOR AND WOOD TRIM MATERIAL TO BE ON SITE TO ACCLIMATE MIN. 7 DAYS PRIOR TO INSTALLATION.

23. FOR ALL OWNER SUPPLIED ITEMS TO BE DELIVERED F.O.B. TAILGATE, CONTRACTOR IS RESPONSIBLE FOR LOADING AND STORAGE OF MATERIALS.

24. COORDINATE DOOR HARDWARE TYPE WITH OWNER/ARCHITECT PRIOR TO BORING DOORS.

25. "JOB COPY" ORIGINAL PERMIT DRAWINGS AND THE ORIGINAL PERMIT CARD TO BE KEPT AT THE JOB SITE AND ACCESSIBLE TO INSPECTORS AT ALL TIMES.

ALL APPLICABLE PERMITS, BONDS, AND INSURANCE. CONTRACTOR TO SAVE AND PROVIDE TO OWNER ALL PAPERWORK AND LITERATURE PROVIDED WITH ANY OWNER AND/OR CONTRACTOR SUPPLIED ITEM.

26. ALL CONTRACTORS AND SUB-CONTRACTORS RESPONSIBLE FOR

27. THE G.C. SHALL NOT PROCEED WITH ANY ADDITIONAL WORK OR CHANGES FOR WHICH HE EXPECTS ADDITIONAL COMPENSATION BEYOND THE ORIGINAL CONTRACT AMOUNT, WITHOUT WRITTEN AUTHORIZATION FROM OWNER. FAILURE TO OBTAIN SUCH AUTHORIZATION SHALL INVALIDATE ANY CLAIM FOR EXTRA COMPENSATION.

28. NO SUBSTITUTION WILL BE ALLOWED WITHOUT PRIOR WRITTEN APPROVAL BY THE ARCHITECT/OWNER.

#### GENERAL NOTES:

31. PROVIDE EXPANSIVE "FIRE-STOP" PUTTY AT ALL THROUGH-PLATE PENETRATIONS AND 2X4 BLOCKING AT ALL SOFFITS. FIRESTOPPING SHALL BE PROVIDED AT ALL JUNCTIONS OF VERTICAL AND HORIZONTAL INCLOSED SPACES, SUCH AS TOPS OF STAIRS, BOT. OR BACK SIDES OF SOPHIST, TOPS OF PLUMBING

32. ALL FLOOR FINISHES SHALL HAVE FLAME SPREAD RATING NOT GREATER THAN 75.

33. THESE DRAWINGS INDICATE THE INTENT, GENERAL CHARACTER, REQUIREMENTS AND APPROXIMATE LOCATION OF THE WORK SHOWN. THE CONTRACTOR SHALL BE EXPECTED TO WORK WITH UNFORESEEN FIELD CONDITIONS, REQUIRING MINOR DESIGN ADJUSTMENTS AND SHALL BE EXPECTED TO PROVIDE A FULLY COMPLETE AND OPERATIONAL BUILDING AND ALL BUILDING

34. ALL CONTRACTORS SHALL INDEMNIFY AND HOLD HARMLESS THE OWNER. THE ARCHITECT AND THEIR AGENTS FROM AND AGAINST CLAIMS DAMAGES, LOSSES AND EXPENSES, INCLUDING ATTORNEY FEES ARISING OUT OF PERFORMANCE OF THE WORK WHEN ANY SUCH CLAIMS ARE ATTRIBUTABLE TO BODILY INJURY, SICKNESS, DEATH, INJURY OR DESTRUCTION TO PROPERTY OR WHEN SUCH CLAIMS ARE CAUSED IN PART OR IN FULL BY ANY NEGLIGENCE OR OMISSION BY THE CONTRACTOR OR HIS AGENTS. THIS NEGLIGENCE INCLUDES FAILURE TO OBSERVE CONTRACT DOCUMENTS PROVIDED BY ARCHITECT.

35. ALL CONTRACTORS TO VISIT PREMISE, NOTE CONDITIONS PERTAINING TO WORK TO BE DONE, CHECK AND VERIFY ALL NOTES, FIGURES AND DIMENSIONS AT THE SITE BEFORE FABRICATING ANY NEW CONSTRUCTION. VARIATION IN FIELD CONDITIONS RELATIVE TO CONTRACT DOCUMENTS SHALL BE REPORTED TO ARCHITECT IN WRITING, AND WORK SHELL NOT PROGRESS UNTIL PERMISSION FROM ARCHITECT OR HIS

36. ALL CONTRACTOR SHALL BE RESPONSIBLE FOR VERIFYING ALL EXISTING CONDITIONS & ELEVATIONS AT THE SITE AND MUST ADOPT HIS WORK TO ACTUAL CONDITIONS IN MANNER APPROVED BY ARCHITECT AT NO ADDITIONAL COST TO OWNER.

37. CONTRACTOR SHALL ASSUME FULL RESPONSIBILITY FOR COMPLIANCE WITH CONTRACT DOCUMENTS, UNRELIEVED BY REVIEW BY SHOP DRAWINGS; FOR DIMENSIONS TO BE CONFIRMED AND CORRELATED ON THE JOB SITE AND BETWEEN INDIVIDUAL DRAWINGS OR SETS OF DRAWINGS; FOR FABRICATION PROCESSES AND CONSTRUCTION TECHNIQUES (INCLUDING SCAFFOLDING, BRACING, ERECTION, ETC); FOR COORDINATION OF THE VARIOUS TRADES: FOR SAFE CONDITIONS ON JOB SITE; AND FOR THE PEOPLE AND PROPERTY AT THE SITE

38. INFORMATION CONTAINING ON THE DRAWING IS IN ITSELF INCOMPLETE, AND VOID UNLESS USED IN CONJUNCTION WITH ALL SPECIFICATIONS, TRADE PRACTICES, AND APPLICABLE STANDARDS, CODES, ETC. INCORPORATED THEREIN BY REFERENCE OF WHICH THE CONTRACTOR CERTIFIES KNOWLEDGE BY SIGNING THE CONTRACT

## SUPERVISION NOTES

THESE PLANS WHERE PREPARED BY THE ARCHITECT FOR DESIGN ONLY. NO SUPERVISION BY THE ARCHITECT SHELL BE PROVIDED AT THE JOB SITE. THE WORK IN PROGRESS OR SCHEDULING ANY WORK RESPECTIVE TO THE JOB SHALL NOT BE GOVERNED BY ARCHITECT.


### SITE NOTES

- CALL 'HOTLINE' TO HAVE EXISTING UNDERGROUND UTILITIES
- VERIFY UTILITY CONNECTIONS WITH UTILITY'S CO. VERIFY AND PROTECT ALL EXISTING UTILITIES.
- CONTRACTOR SHALL RESTORE EXISTING LAWN AREAS, CONCRETE SLABS, CURBS, PAVEMENT, ETC. DAMAGED BY
- OR DURING CONSTRUCTION. ALL DUMPSTERS, STRUCTURES, OR CONTAINERS SHALL BE COVERED AT ALL TIMES WHEN NO WORK IS BEING PERFORMED ON THE PROPERTY THAT IS THE SUBJECT OF



BUILDING WILL NOT HAVE FIRE SPRINKLER SYSTEM INSTALLED

//1 \ 01/09/2024

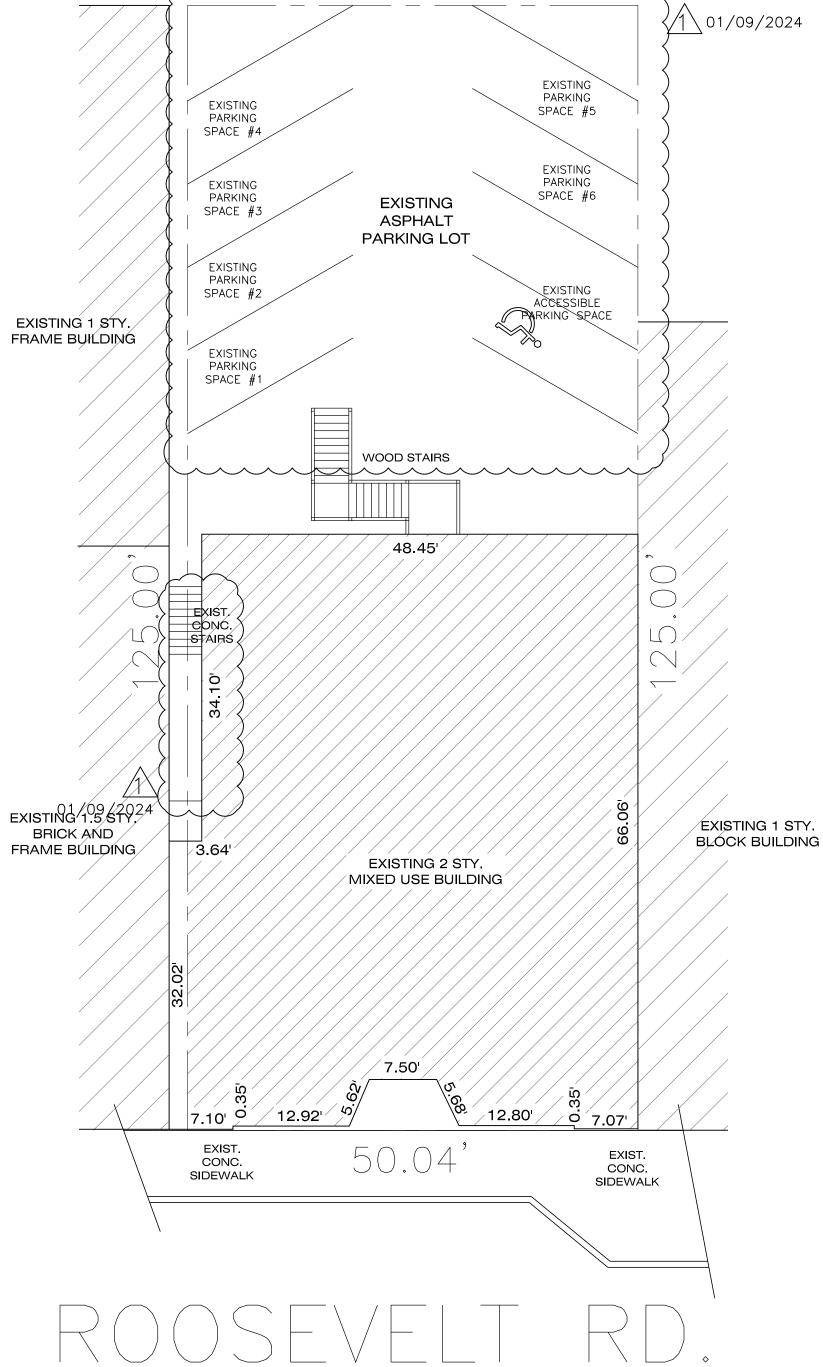







BASEMENT: -REPLACE HVAC SYSTEM -UNISEX RESTROOM -STAIR OPENING


SECOND FLOOR:
-ADA RESTROOMS -REPLACE CABINETS -NEW INTERIOR LAYOUT

---- PROPERTY LINE



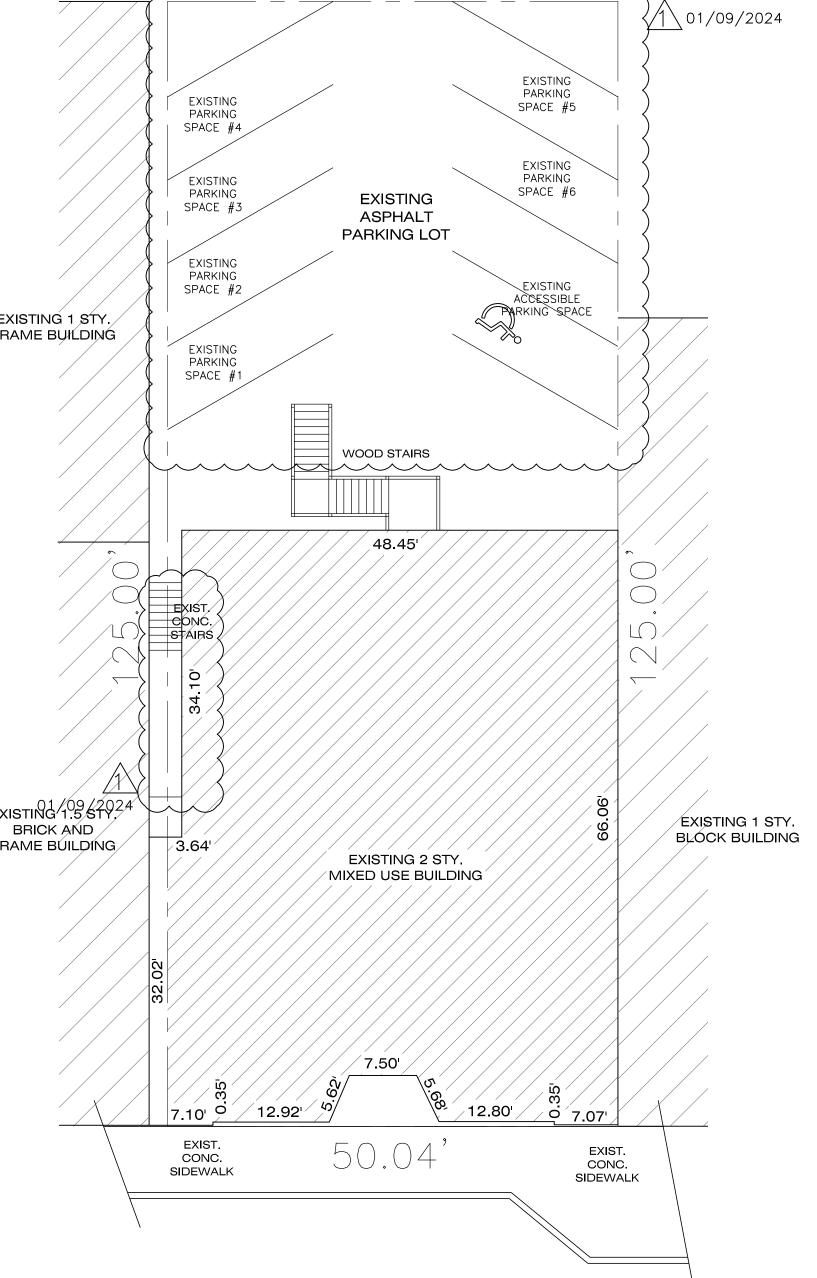

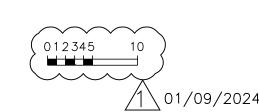

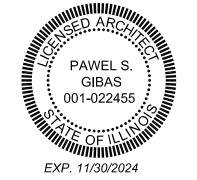

### **CERTIFICATION STATEMENT**

M3 ) MECHANICAL SCHEDULES AND NOTES

E2 | ELECTRICAL SCHEDULES, DIAGRAM AND NOTES

STUDIO.G ARCHITECTS LLC IS AN ILLINOIS REGISTERED DESIGN FIRM LICENSE NO. 184.006949-0001

I HEREBY CERTIFY THAT THESE PLANS WERE PREPARED UNDER MY DIRECT SUPERVISION AND TO THE BEST OF MY PROFESSIONAL KNOWLEDGE THEY CONFORM TO THE 2018 International Building Code, as noted on sheet T1



DATE: <u>12/17/2023</u>

<u>/\</u> 01/09/2024

**REVISIONS:** 





**BUSINESS INFO:** 

ZONING DATA: 'RR' ZONING DISTRICT

ZONING DATA: 'RR' ZONING DISTRICT

BUILDING DATA

YES

Illinois State Plumbing Code - 2014 version

with Illinois Amendments

SHT.

T2 NOTES

Illinois Accessibility Code - 2018

T1 TITLE SHEET, SITE PLAN AND NOTES

D1 DEMOLITION PLANS AND NOTES

D2 DEMOLITION PLAN AND NOTES

A1 PROPOSED PLAN & SCHEDULES

A2 PROPOSED PLAN & SCHEDULES

A4 SECTION AND ADA DETAILS

P1 PLUMBING DIAGRAMS

M1 MECHANICAL PLANS

M2 MECHANICAL PLANS

E1 ELECTRICAL PLANS

A3 EGRESS PLANS

International Existing Building Code - 2018 version

CONSTRUCTION EXISTING PROPOSED OCCUPANCY
TYPE USE GROUP USE GROUP CHANGE

(RETAIL STORE) (PROFESSIONA

ORDINANCE

FIRST FLOOR.

SECOND FLOOR

TOTAL BUILDING

FRONT YARD SETBACK

SIDE YARD SETBACK. REAR YARD SETBACK.

BUILDING HEIGHT.

1ST FLOOR | IIIA

2ND FLOOR IIIA

01/09/2024

01/09/2024

6,255 S.F.

. 3.188.9 S.F.

3,287.7 S.F.

6,476.6 S.F.

2,985.8 SF INTERIOR

3,003.1 SF INTERIOR

**CODES REFERENCED** 

International Building Code - 2018 version with amendments

International Mechanical Code - 2018 version with amendments

International Fuel Gas Code - 2018 version with amendments

SHEET INDEX

DESCRIPTION

International Fire Code - 2018 version with amendments

National Electric Code - 2017 version with amendments

International Energy Conservation Code - 2018 version

Phone: 708-683-9725

Journey's Community Center

www.journeyscommunity.com

01/09/2024

WORK FIRE RATED FIRE RATED ALTERATION AREA WALLS CEILINGS LEVEL

F INTERIOR 3 HR FR 1 HR FR



3 **09** 

Δ

**DRAWING TITLE:** 

TITLE SHEET SITE PLAN & NOTES

# REVIEWED FOR REVISION 3 AND 4 ONLY

#### **ABBREVIATIONS LIST** ABV: NOM: Nominal ADH: Adhesive ABW: N: North ADJ: Adjustable ABX: NIC: Not in Contract AFF: Above Finish Floor ABY: NTS: Not To Scale AGG: Aggregate ABZ: NO, #: Number ACA: OBS: Obscure A/C: Air Conditioning ANC: Anchor, Anchorage ACB: OC: On Center AB: Anchor Bolt ACC: OPG: Opening ACD: OSB: Orientated Strand Board ANOD: Anodized ACE: OD: Outside Diameter APX: Approximate ACF: PMT: Paint(ed) AVE: Avenue ACG: PBD: Particle Board AVR: Average BSMT: ACH: PRT: partition BM: Beam ACI: PVMT: Pavement BLW: Below ACJ: PLAS: Plaster BLDV:Boulevard ACK: PLT: Plate BTW: Between ACL: PCC: Precast Concrete ACM: PCF: Pounds Per Cubic Foot BD: Board ACN: PLF: Pounds Per Linear Foot BLDG: Building B/O: By Others ACO: PSF: Pounds Per Square Foot BO: Bottom Of ACP: PSI: Pounds Per Square Inch CAB: Cabinet ACQ: PBF: Prefabricated ACR: PRF: Preformed ACS: PT: Pressure Treated CD: Cabinet Door CG: Corner Guard ACT: PL: Property Line ACU: QTY: Quantity CL: Centerline ACV: RAD: Radius CO: Clean Out CIP: cast-in-place ACW: REF: Reference CB: Catch Basin ACX: RFL: Reflect(ed),(ive),(or) CLG: Ceiling ACY: REFR: Ref ACZ: REG: Register CT: Ceramic Tile CLR: Clear ADA: RE: Reinforced COL: Column ADB: REQ'D: Required CONC: Concrete ADC: RA: Return Air CMU: Concrete Masonry Unit ADD: REV: Revision CONST: CONSTruction ADE: R: Riser CONT ADF: RFG: Roofing Continuous CJT: Control Joint ADG: RM: Room ADH: RO: Rough Opening Corrugated CUFT: Cubic Foot ADI: SCH: Schedule CUYD: ADJ: SCN: Screen Cubic Yard DP: Dampproofing ADK: SECT: Section DTL: Detail ADL: SHTH: Sheathing DIA: Diameter ADM: SHT: Sheet DIM: Dimension ADN: SIM: Similar DW: Dishwasher ADO: SKL: Skylight DIV: Division ADP: S: South ADQ: SPEC: Specification DR: Door DH: Double Hung ADR: SQ: Square ADS: STD: Standard DS: Downspout ADT: STV: Stove DT: Drain Tile ADU: STL: Steel ADV: SA: Supply Air DWG: Drawing D: Nail Size ADW: SC: Solid Core ADX: SW: Shear Wall EW: Each Way E: East ADY: SS: Stainless Steel ADZ: SYS: System EL: Elevation **ELEV: Elevation** AEA: TEL: Telephone AEB: TEMP: Tempered EQ: Equal EQP: Equipment AEC: T&G: Tongue and Groove AED: T/O: Top of EXCV: Excavate AEE: TB: Towel Bar EXH: Exhaust EXIST: Existing AEF: T: Tread EXT: Exterior AEG: TS: Tubular Steel AEH: TYP: Typical FCB: Fiber Cement Board FGL: Fiberglass AEI: UL: Underwriters Laboratory FIN: Finish AEJ: UNF: Unfinished AEK: UNO: Unless Noted Otherwise FA: Fire Alarm FE: Fire Extinguisher AEL: VB: Vapor Barrier FLSH: Flashing AEM: VAR: Varnish FLR: Floor AEN: VIF: Verify In Field FLOR:Fluorescent AEO: VRN: Veneer FT: Foot, Feet AEP: VERT: Vertical FTG: Footing AEQ: WC: Water Closet FND: Foundation AER: WH: Water Heater FRM: Fram(d), (ing) AES: WP: Water Proofing FBO: Furnished by Others AET: WR: Weather Resistant FUR: Furred AEU: WRB: Weather Resistive Barrier GA: Gage, Gauge AEV: WWF: Welded Wire Fabric GAL: Gallon AEW: WWM: Welded Wire Mesh GL: Glass, Glazing AEX: W: West GI: Galvanized Iron AEY: WIN: Window GLBK: Glass Block AEZ: W/O: Without GRD: Grade, Grading AFA: W/: With GWB: Gypsum Wall Board AFB: WD: Wood HWD: Hardware HDR: Header HTG: Heating HVAC: Heating, Ventilation-Air Conditioning HT: Height HC: Hollow Core HOR: Horizontal HB: Hose Bib IN: Inch INCL: Include ID: Inside Diameter INS: Insulate INT: Interior JNT: Joint JST: Joist KIT: Kitchen LB: Pound LAV: Lavatory LH: Left Hand L: Length LOA: Length Overall LT: Light LF: Lineal Feet LL: Live Load LVL: Laminated Veneer Lumber LVR: Louver MFR: Manufacturer MO: Masonry Opening MAX: Maximum MAS: Masonry MECH: Mechanic(al) MED: Medium

MBR: Member

MMB: Membrane MTL: Metal

MIN: Minimum
MISC: Miscellaneous
MLB: Micro Laminate Beam

#### **GENERAL NOTES:**

1. THE GENERAL CONTRACTOR SHALL VERIFY ALL EXISTING CONDITIONS AND DIMENSIONS BEFORE STARTING WORK AND REPORT ANY DISCREPANCIES TO THE ARCHITECT IN WRITING.

2. THE GENERAL CONTRACTOR SHALL OBTAIN, IF REQUIRED, ALL NECESSARY PERMITS

3. IT IS THE RESPONSIBILITY OF THE CONTRACTOR WORKING AT THE SITE TO PROTECT THE OWNER'S EXISTING STRUCTURES, EQUIPMENT, FURNISHING, ETC., FROM DAMAGE DUE TO HIS WORK.

4. THE CONTRACTOR SHALL BE RESPONSIBLE FOR FIXING AND/OR REPLACING ANYTHING EXISTING ON THE SITE, BUILDING UTILITIES, OR ANY OTHER OWNER EQUIPMENT THAT IS DAMAGED AS A RESULT OF HIS WORK.

5. ALL WORK SHALL BE PERFORMED IN A GOOD WORKMANLIKE MANNER. ALL SUBCONTRACTORS SHALL REMOVE THEIR DEBRIS AND LEAVE THE JOB SITE BROOM SWEPT AT THE AND OF EACH WORK DAY.

6. EACH AND EVERY CONTRACTOR AND SUBCONTRACTOR PERFORMING WORK AT THE SITE OF THE PROJECT TO WITCH THIS CONTRACT RELATES, SHALL COMPLY WITH APPLICABLE PROVISIONS OF ALL PERTINENT FEDERAL AND STATE LABOR LAWS.

7. ALL PLUMBING SHALL MEET THE REQUIREMENT OF THE 2014 ILLINOIS PLUMBING CODE.

8. ALL SUPPLY, RETURN AND EXHAUST DUCT OPENING SHALL BE CAPPED WITH SUITABLE MATERIAL DURING CONSTRUCTION.

9. ALL ELECTRICAL WORK SHALL COMPLY WITH 2017 NATIONAL ELECTRICAL CODE ELECTRICAL SHOWN ON PLANS IS SCHEMATIC ONLY. SERVICE PANELS SHALL BE LABELED TO IDENTIFY THEIR SERVICE AREAS.

10. ALL TRADES SHALL DO THEIR OWN CUTTING, FITTING PATCHING, ETC., TO MAKE THE SEVERAL PARTS COME TOGETHER PROPERLY AND FIT IT TO RECEIVE OR BE RECEIVED BY WORK OF OTHER TRADES.

11. THE INTENTION OF THESE DOCUMENTS IS TO INCLUDE ALL LABOR, MATERIALS SERVICES, EQUIPMENT AND TRANSPORTATION NECESSARY FOR THE COMPLETE AND PROPER EXECUTION OF THE WORK INDICATED ON DRAWINGS OR REASONABLY INFERRED THEREFROM.

12. THE CONTRACTOR AND ALL SUBCONTRACTORS SHALL MAINTAIN SUCH INSURANCE AS WILL PROTECT HIM FROM CLAIMS UNDER WORKMAN'S COMPENSATION ACTS AND OTHER EMPLOYEE BENEFIT ACTS; FROM CLAIMS FOR DAMAGES BECAUSE OF BODILY IN JURIES, INCLUDING DEATH TO HIS EMPLOYEES AND ALL OTHERS, FROM CLAIMS FOR DAMAGES TO PROPERTY ANY OR ALL OF WHICH MAY ARISE OUT OF OR RESULT FROM THE CONTRACTOR'S OPERATIONS UNDER THIS CONTRACT.

ALL INSURANCE REQUIRED SHALL INCLUDE INDEMNIFICATION AND HOLD HARMLESS PROVISIONS COVERING BOTH THE OWNER AND ARCHITECT.

13. THE ARCHITECT SHALL NOT HAVE CONTROL OR CHARGE OF AND SHALL NOT BE RESPONSIBLE FOR CONSTRUCTION MEANS, METHODS, TECHNIQUES, SEQUENCES OR PROCEDURES, OR FOR SAFETY PRECAUTIONS AND PROGRAMS IN CONNECTION WITH THE WORK, FOR THE ACTS OR OMISSIONS OF THE CONTRACTOR, SUBCONTRACTORS OR ANY OTHER PERSONS PERFORMING ANY OF THE WORK, OR FOR THE FAILURE OF ANY OF ITEM TO CARRY OUT THE WORK IN ACCORDANCE WITH THE CONTRACT

14. DURING CONSTRUCTION, ALL NECESSARY PRECAUTIONS SHALL BE OBSERVED SO AS TO PREVENT ANY HAZARDOUS CONDITIONS TO OCCUPANTS STILL USING OTHER PORTIONS OF THE BUILDING. FLAMMABLE FINISHES SHALL NOT BE STORED ON THE SITE UNTIL THEY ARE TO BE USED. PORTABLE FIRE EXTINGUISHING EQUIPMENT SHALL BE KEPT IN THE CONSTRUCTION AREA. COMBUSTIBLE RUBBISH AND SCRAP CONSTRUCTION MATERIALS SHALL BE REMOVED FROM THE SITE DAILY.

#### CARPENTRY NOTES

1. PROVIDE ALL CARPENTRY WORK SPECIFIED WITHIN AS SHOWN. INSTALL ALL MILLWORK. ROUGH AND FINISHED LUMBER. SASH. DOORS AND FRAMES AND CABINETRY.

2. NO STRUCTURAL MEMBER SHALL BE CUT WITHOUT THE APPROVAL OF THE ARCHITECT

3. PROVIDE ALL NECESSARY ITEMS OF BUILDER'S HARDWARE TO ASSEMBLE AND/OR SECURE WORK AS SHOWN OR SPECIFIED UNDER CARPENTRY OR MILLWORK. DO ALL REFITTING OR ADJUSTING FOR A PERIOD OF ONE YEAR AFTER FINAL PAYMENT AND AT NO COST TO THE OWNER. AFTER REFITTING. REFINISH WOODWORK AS SPECIFIED FOR ORIGINAL INSTALLATION.

4. USE APPROVED FIRE BLOCKING IN EVERY REQUIRED LOCATION.

5. PROVIDE FIRESTOPPING.

6. CAULKING. CAULK ALL JOINTS BETWEEN SIMILAR AND DISSIMILAR MATERIALS, INTERIOR AND EXTERIOR, AS DETAILED AND REQUIRED TO PREVENT AIR AND WATER INFILTRATION.

7. PROVIDE 26 GAUGE G.I. METAL FLASHING AT ALL MISCELLANEOUS FLASHINGS THAT HAVE NOT BEEN SPECIFIED OTHERWISE

8. DO NOT CUT OR DRILL THROUGH THE BOTTOM THIRD OF ANY BEAM OR JOIST.

9. DRYWALL NOTE: USE %" GYPSUM BOARD THROUGHOUT, USE FIRECODE TYPE 'C' AT CEILINGS.

#### LUMBER NOTES:

1. ALL LUMBER SHALL BE HEM-FIR, No.2 (OR SOUTHERN YELLOW PINE, No.2), PRESSURE TREATED WITH THE FOLLOWING MINIMUM ALLOWABLE STRESSES:
- ALLOWABLE BENDING STRESS Fb = 850 psi

ALLOWABLE BENDING STRESS FD = 850 psi
 ALLOWABLE HORIZONTAL SHEAR Fv = 150 psi
 MODULUS OF ELASTICITY F= 1,300,000 psi
 MAXIMUM ALLOWABLE MOISTURE CONTENT SHALL BE 19%

REVISIONS:

WILLAGE OF OAK PARK
CONSTRUCTION DOCUMENT(S)

REVIEWED FOR COMPLIANCE

The translation of the control of the co







SCALE: 1/4" = 1'-0"

DATE:

PARK IL 60

AME:

DRAWING TITLE:

DEMOLITION PLAN AND NOTES

#### **DEMOLITION NOTES:**

1. THE DEMOLITION CONTRACTOR IS TO VISIT SITE TO BECOME FAMILIAR WITH SCOPE OF WORK PRIOR TO BIDDING AND START OF WORK.

2. DEMOLITION CONTRACTOR TO PROVIDE PROPER BARRICADES TO SECURE AREA FROM PUBLIC OCCUPATION. ALSO, BARRICADES TO BE INSTALLED AT ALL LOCATIONS WHERE HAZARDS EXIST FOR PUBLIC SAFETY.

3. CONTRACTOR TO PROVIDE ALTERNATE TO TAKE OUT ALL NECESSARY INSURANCES TO INDEMNIFY AND HOLD HARMLESS THE OWNER, ARCHITECT AND AGENTS THEREOF FROM ANY DAMAGES RESULTING FROM CONTRACTOR'S EXECUTION OF WORK.

4. ALL DEMOLITION WORK TO BE DONE IN A MANNER AS TO PROTECT ALL EXISTING CONSTRUCTION THAT IS TO REMAIN. EXTREME CARE TO BE TAKEN AT INTERFACE BETWEEN CONSTRUCTION TO REMAIN AND THAT TO BE DEMOLISHED.

5. THE CONTRACTOR SHALL USE EVERY PRECAUTION TO SECURE BUILDING AND SAFEGUARD ALL PERSONS AND PROPERTY INCLUDING ADJOINING PROPERTY FROM DAMAGE.

6. DEMOLITION OF EXISTING UTILITIES TO BE DONE PER REQUIREMENTS OF LOCAL AUTHORITIES. CONSULT RESPECTIVE DISCIPLINES FOR EXTENT OF

7. ALL DEMOLITION MATERIAL TO BE MOVED OFF SITE BY DEMOLITION CONTRACTOR.

8. IN NO CASE SHALL DIMENSIONS BE SCALED FROM DRAWINGS. THE CONTRACTOR SHALL VERIFY ALL CONDITIONS AND DIMENSIONS IN THE FIELD BEFORE PROCEEDING WITH SUBSEQUENT WORK. THE DEVELOPER'S REPRESENTATIVE AND ARCHITECT SHALL BE NOTIFIED OF ANY DISCREPANCIES FOR CLARIFICATION PRIOR TO PROCEEDING WITH WORK.

DEVELOPER'S REPRESENTATIVE EXACT EXTENT OF DEMOLITION AT CRITICAL AREAS AND THOSE AREAS NOT DETAILED PRIOR TO BID SUBMITTAL.

10. CONTRACTOR TO PROTECT AND STORE ON SITE ANY ITEMS MARKED "SAVE" OR "SALVAGE". COORDINATE LOCATION WITH OWNER.

TO THE GOVERNING JURISDICTION REQUIREMENTS FOR ENVIRONMENTAL ITEMS SUCH AS, BUT NOT LIMITED TO, NOISE AND DUST CONTROL.

12. THE DEMOLITION CONTRACTOR IS TO DISCONNECT ALL SERVICE ITEMS (I.E. ELECTRICAL, PLUMBING, FIRE PROTECTION, ETC.) WHICH OCCUR IN THE DEMOLISHED AREA (S) PRIOR TO THE START OF WORK. CONTRACTOR TO COORDINATE SERVICE SHUT-DOWN WITH ALL INVOLVED PARTIES AND CONSULT RESPECTIVE UTILITY COMPANIES FOR **EXACT TERMINATION REQUIREMENTS.** 

13. THE DEMOLITION CONTRACTOR IS TO PROVIDE WRITTEN NOTICE TO ALL AFFECTED PARTIES OF A UTILITY SHUT-DOWN 5 DAYS PRIOR TO WORK BEING DONE. ALSO, PROVIDE THE OWNER WRITTEN NOTICE OF SUCH WORK.

14. AFTER DEMOLITION OF ANY EXTERIOR ELEMENT OF EXISTING STRUCTURE, CONTRACTOR TO PROVIDE AN AIR-TIGHT, WEATHERPROOF, INSULATED SECURE ENCLOSURE.

15. DEMOLISH AND REMOVE PARTITIONS, DOORS, FRAMES, ACCESSORIES ETC. IF THERE IS A QUESTION REGARDING THE DEMOLITION OF A PARTICULAR ITEM. THAN ASK THE OWNER'S ON SITE REPRESENTATIVE PRIOR TO DEMO AND REMOVAL.

16. CUT OUT AND REMOVE ALL WATER PIPES, WASTE LINES AND OTHER PIPES BELOW THE ROOF DECK AND TO THE FLOOR LEVEL THAT ARE NOT OR WILL NOT BE USED. CAP ALL PIPES AT THE ROOF DECK AND BELOW THE FLOOR LINE SO THAT THE FLOOR MAY BE PATCHED AND FINISHED FLUSH WITH THE EXISTING FLOOR.

17. REMOVE ALL ABANDONED HANGERS, WIRES, ANCHORS, ETC. FROM FLOOR LEVEL TO ROOF DECK.

18. EXISTING ELECTRICAL EQUIPMENT WHICH IS TO REMAIN AND HAS BEEN DISCONNECTED THROUGH DEMOLITION AND INSTALLATION OF NEW WORK SHALL BE RECONNECTED TO ITS ORIGINAL AND/OR NEW SOURCE

19. ALL ELECTRICAL OUTLETS, DEVICES, FIXTURES, ETC. NOT BEING RE-USED SHALL BE REMOVED AND OUTLETS ARE TO BE CAPPED. ALL WIRING SHALL BE REMOVED COMPLETELY. EXISTING FIXTURES NOT BEING RE-USED SHALL BE RETURNED TO OWNER. EQUIPMENT THAT THE OWNER DOES NOT WANT SHALL IMMEDIATELY BE REMOVED FROM THE SITE BY THIS DEMOLITION CONTRACTOR.

20. THE DEMOLITION CONTRACTOR SHALL HAVE A ROOFING CONTRACTOR PATCH ROOF DECK AND ROOFING MEMBRANE IF ANY DEMOLITION LEAVES HOLES IN THE ROOF.

21. PROTECT EXISTING ROOF DRAIN AND RAIN WATER LEADERS.


22. MARK LOCATION OF UTILITIES.

23. DO NOT BURN OR BURY MATERIALS ON SITE.

24. REMOVE ALL TEMPORARY WORK WHEN DEMOLITION IS COMPLETE.

25. LEAVE THE THE BUILDING BROOM CLEANED AFTER DEMOLITION WORK IS COMPLETED.

26. CONTRACTOR MUST PROVIDE ADEQUATE SHORING AND BRACING OF EXISTING STRUCTURE AT ALL TIMES AND PERFORM ALL DEMOLITION IN A SAFE AND CONSIDERED MANNER, WITHOUT DAMAGING CONSTRUCTION TO REMAIN.

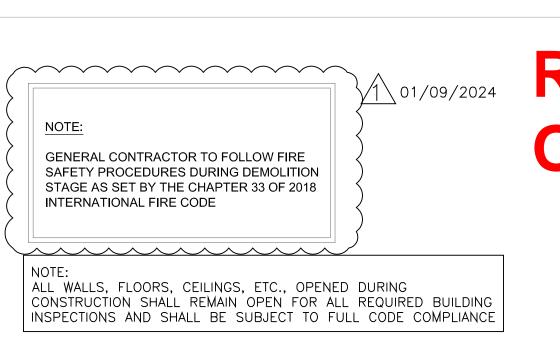

ELECT.

PANEL


EXISTING CONCRETE

-EXISTING CONCRETE

RETAINING WALL

\p1/09/2024

**REVIEWED FOR REVISION 3 AND 4 ONLY** 

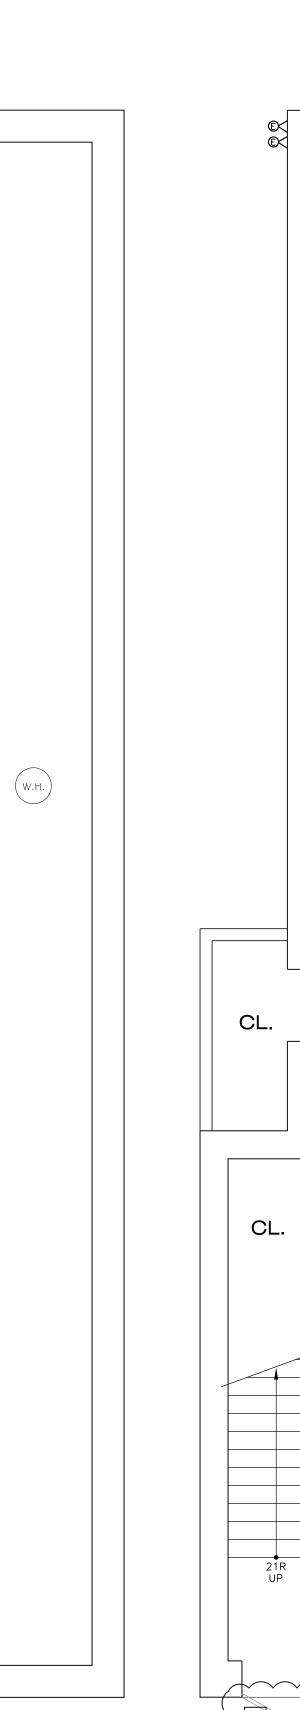


**BASEMENT** 

SPACE

BASEMENT EXISTING PLAN

SCALE: 1/4" = 1'-0"

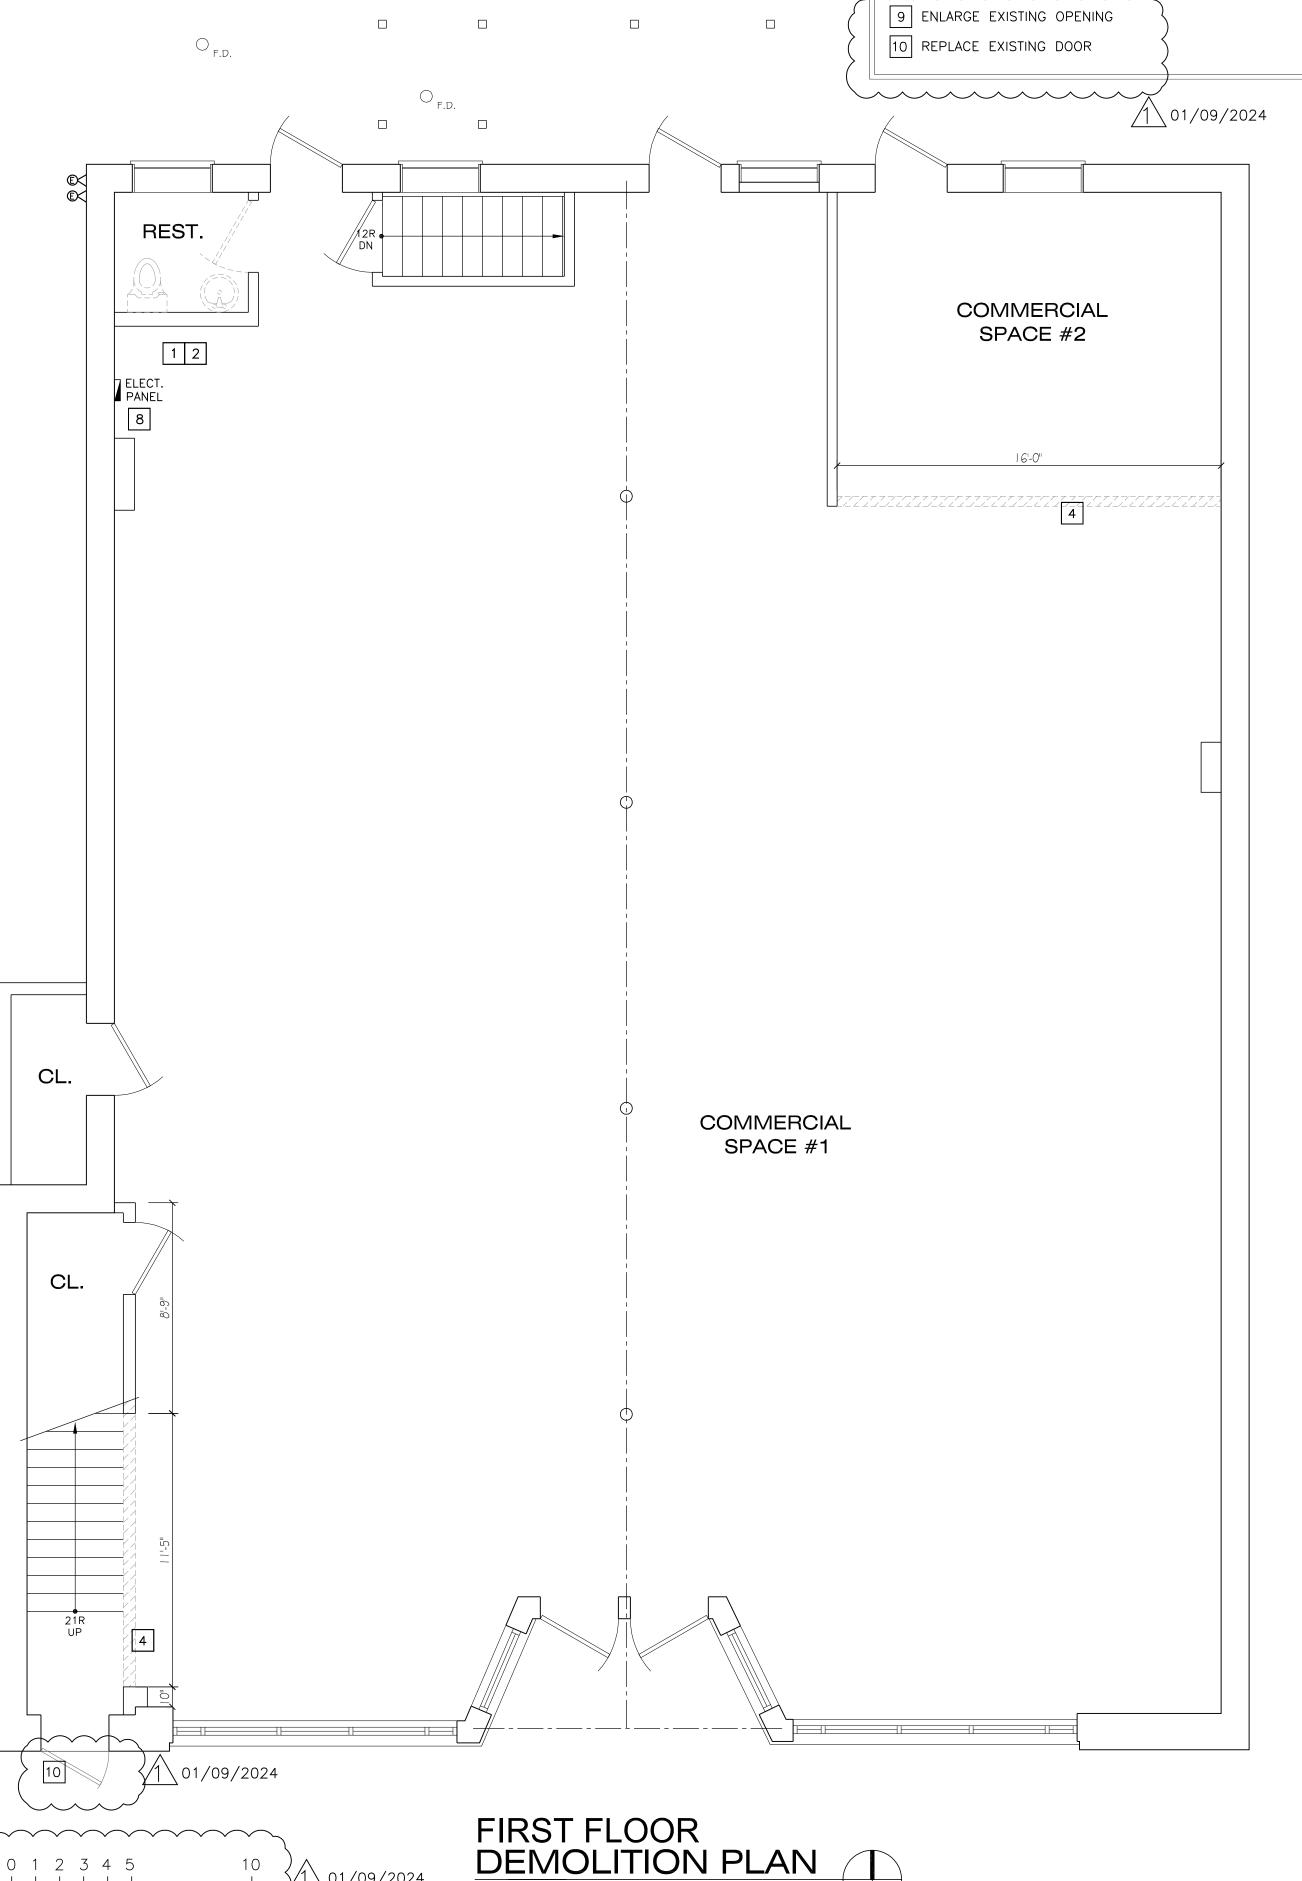

√1 \ 01/09/2024



1 REMOVE EXISTING PLUMBING FIXTURES.

2 REMOVE EXISTING CABINETS. REPLACE EXISTING FURNACE AND ASSOCIATED DUCTWORK

4 REMOVE EXISTING WALL

FEMOVE EXISTING DOOR. INFILL OPENING WITH GYPSUM BOARD AND WOOD STUDS

6 REMOVE EXISTING WALL, PREPARE OPENING FOR NEW DOOR

7 REMOVE EXISTING DROP CEILING

8 REMOVE EXISTING ELECTRICAL PANELS


**REVISIONS:** 

CONSTRUCTION DOCUMENT(S)

EVIEWED FOR COMPLIANCE

<u>/1\</u> 01/09/2024


<u>A</u> 01/26/2024

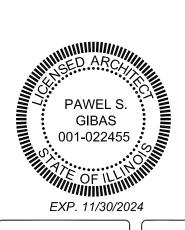

6030

DRAWING TITLE:

**DEMOLITION PLAN AND NOTES** 

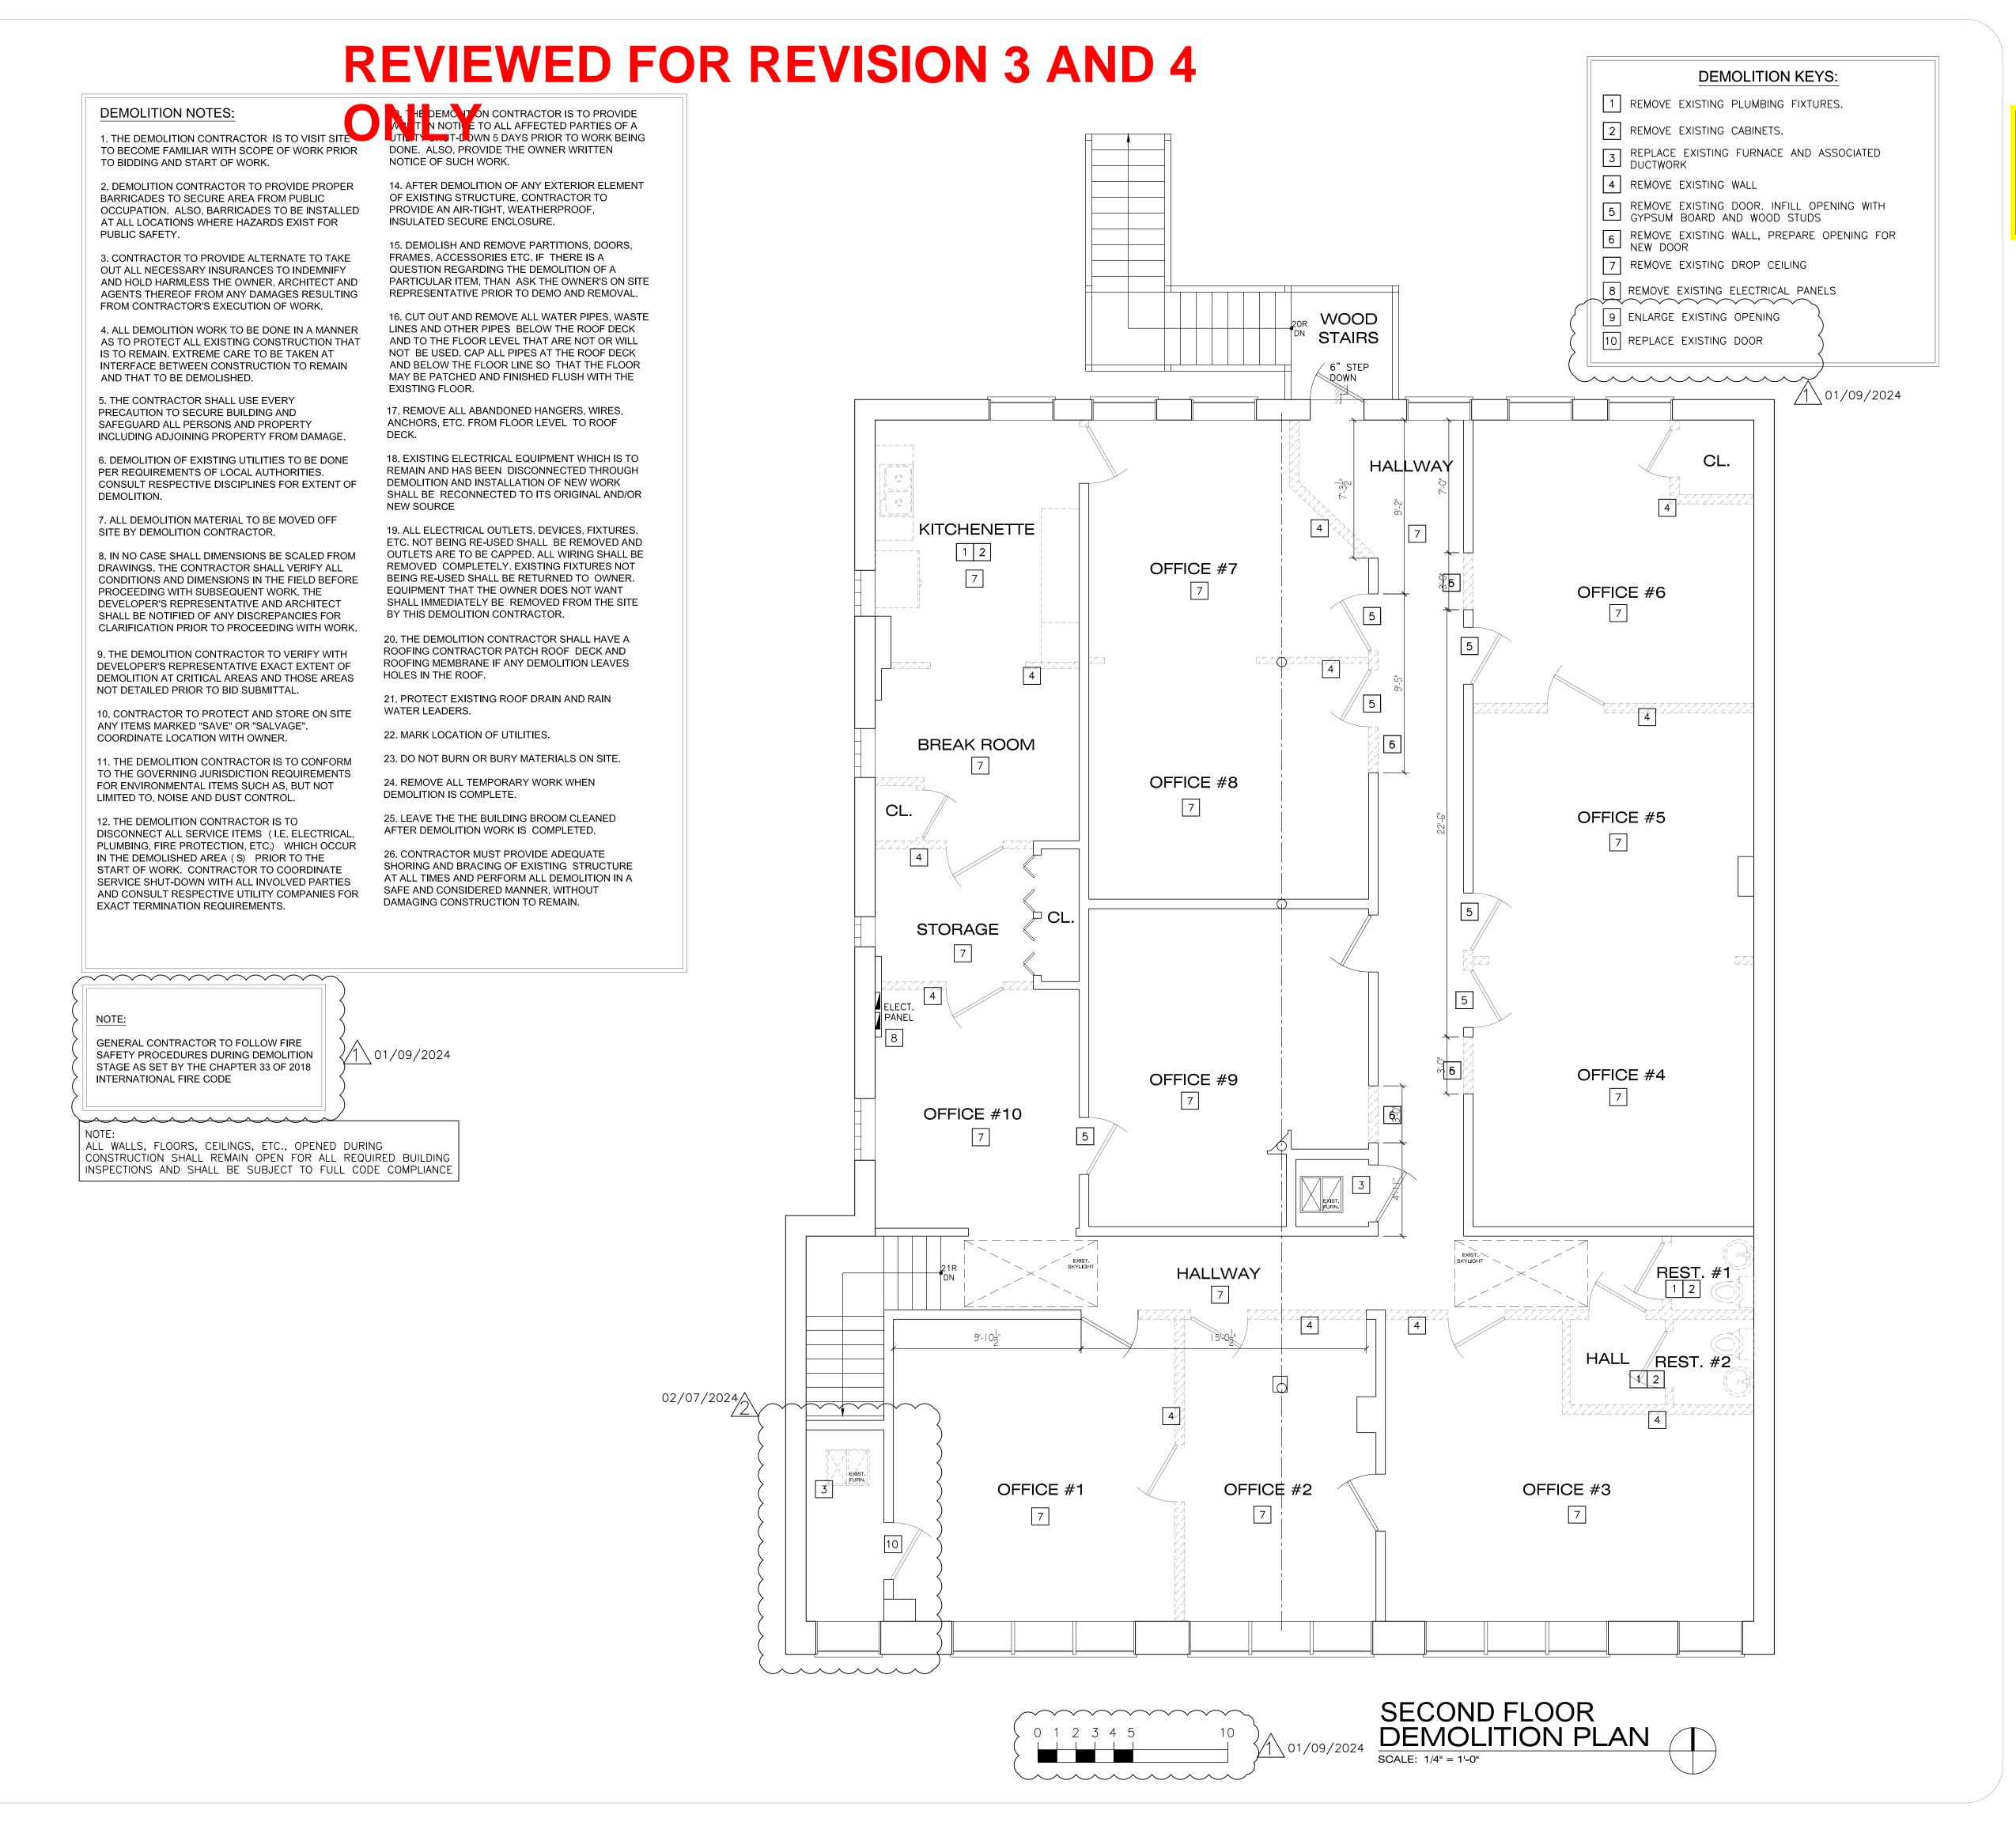

<u>/1\</u> 01/09/2024 <u>2</u> 02/07/2024

CONSTRUCTION DOCUMENT(S) **EVIEWED FOR COMPLIANCE** 






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DRAWING TITLE:

**DEMOLITION PLAN AND NOTES** 



<u>A</u> 03/26/2024

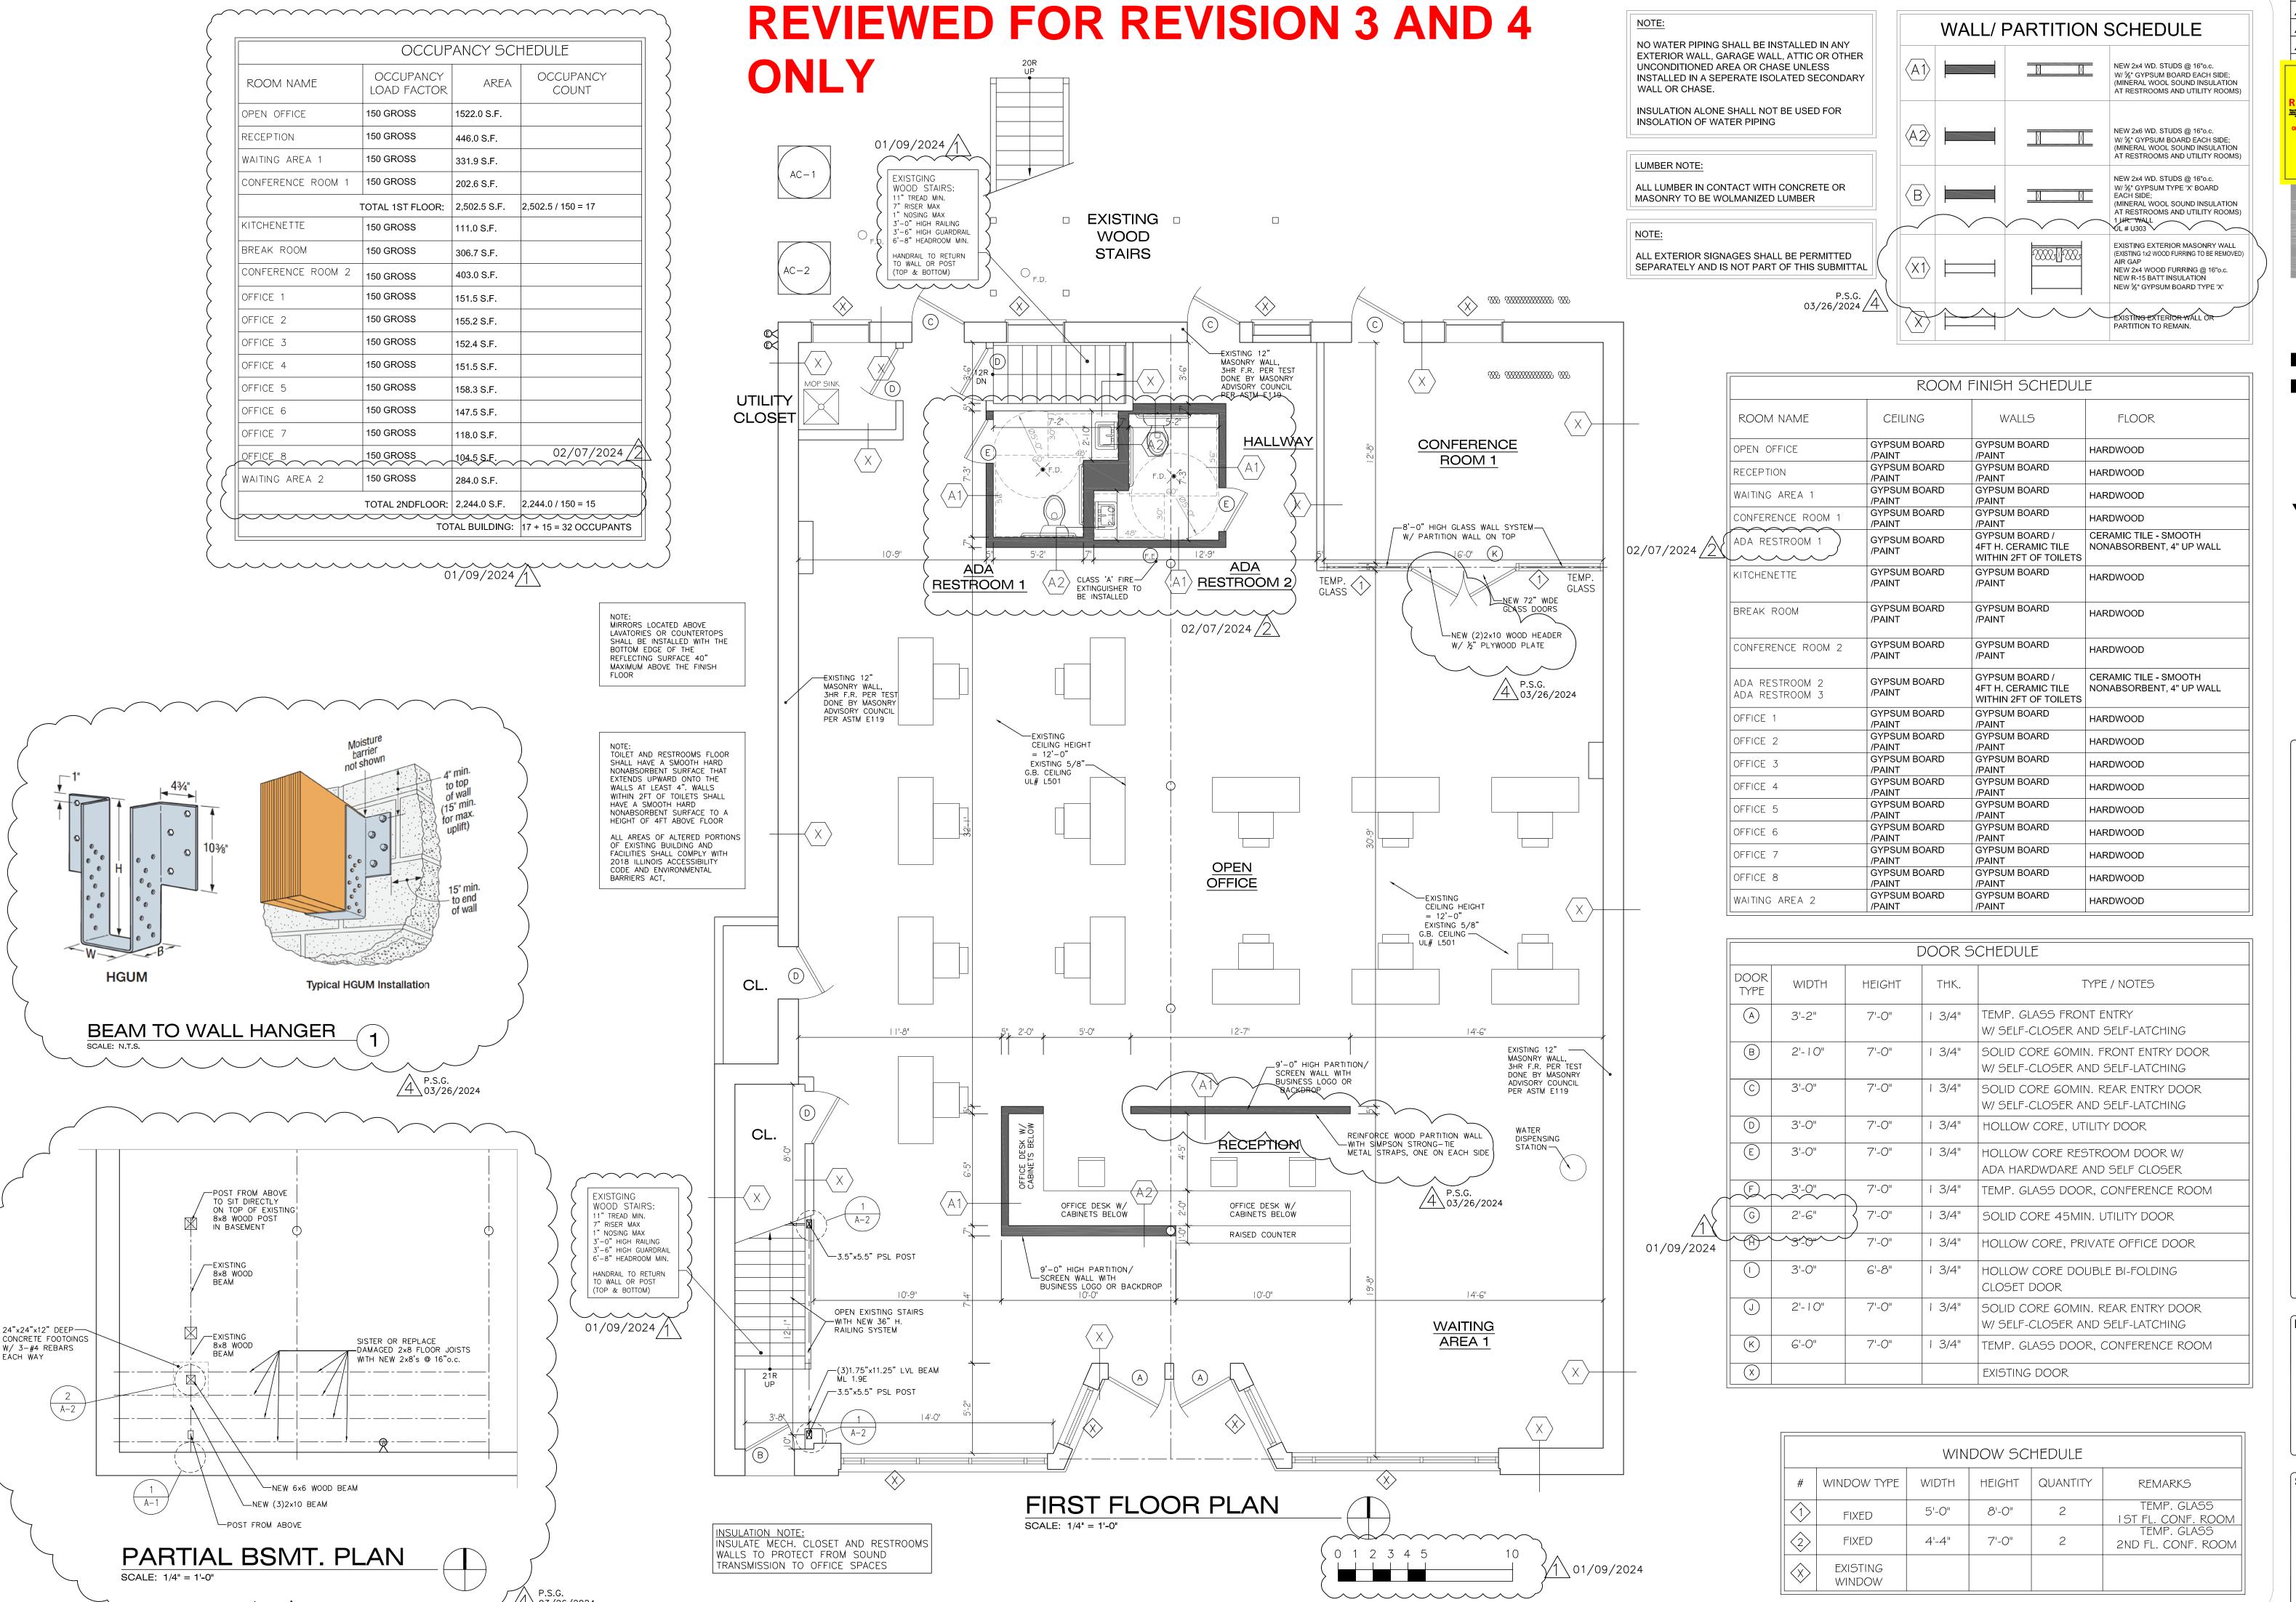CONSTRUCTION DOCUMENT(S EVIEWED FOR COMPLIANC






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DRAWING TITLE:

**PROPOSED PLANS** 



<u>A</u> 02/07/2024  $\triangle$  03/11/2024 (FIELD REVISIONS)

**EVIEWED FOR COMPLIANCE** 

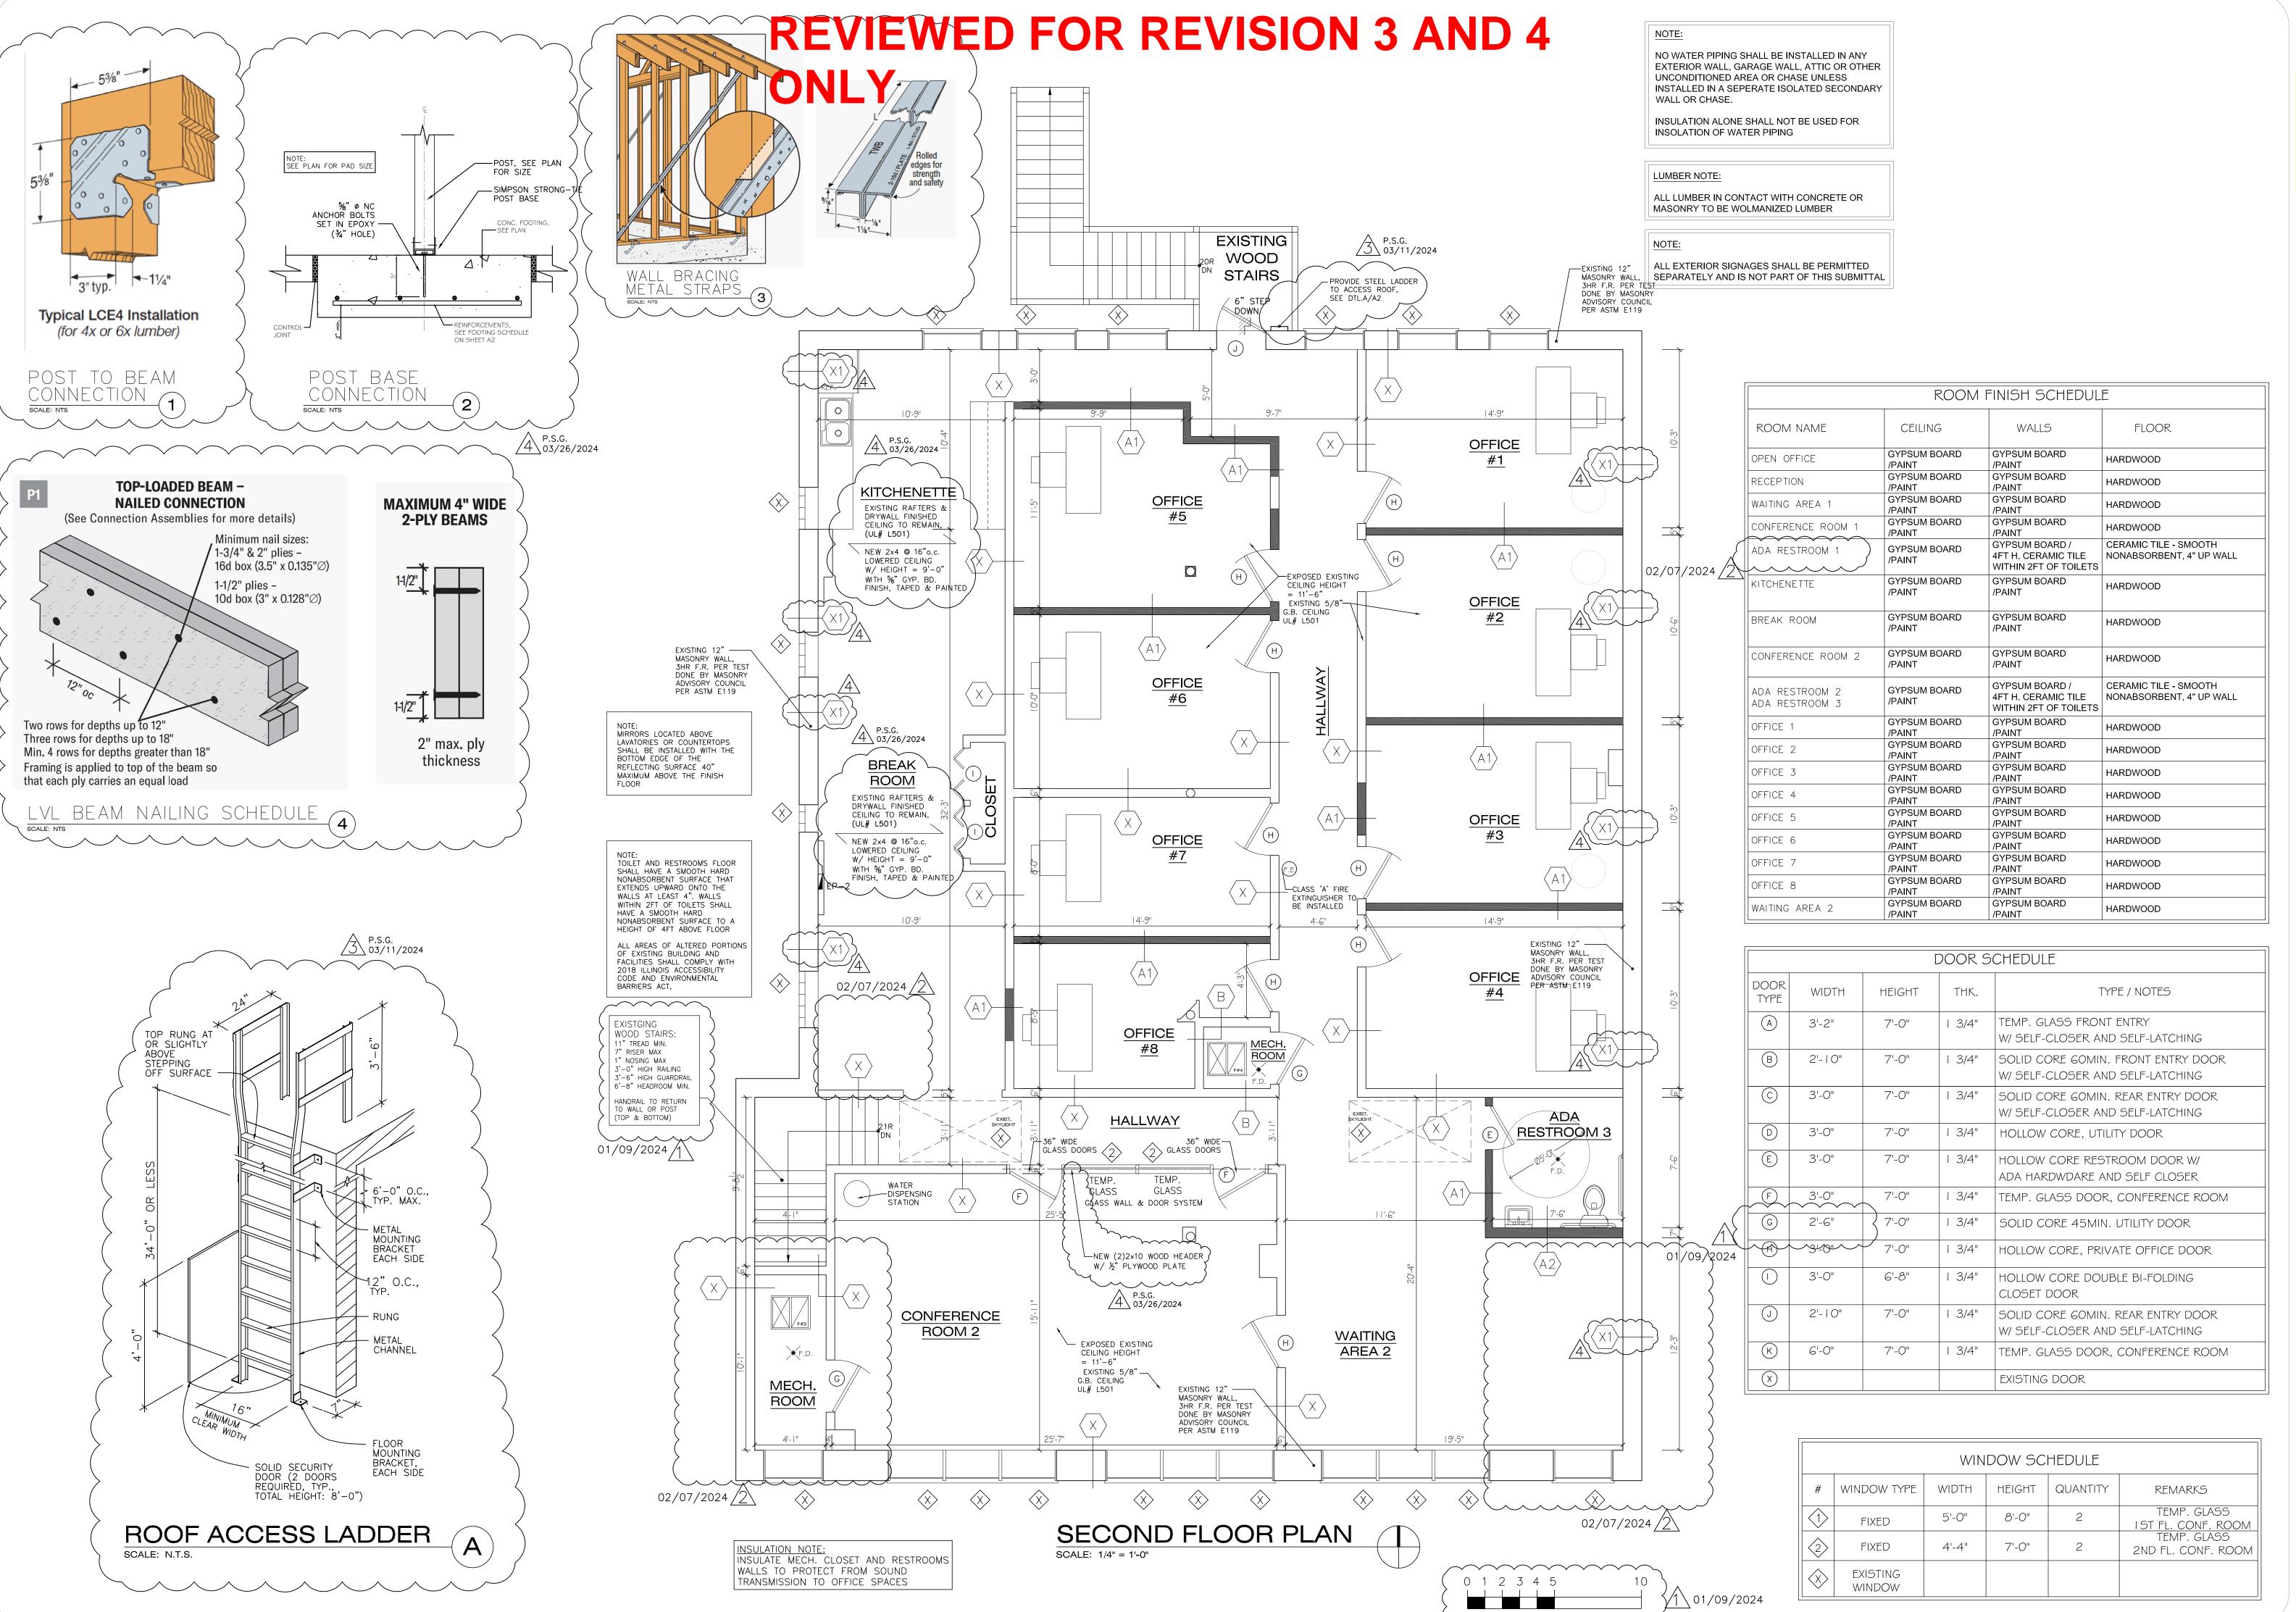



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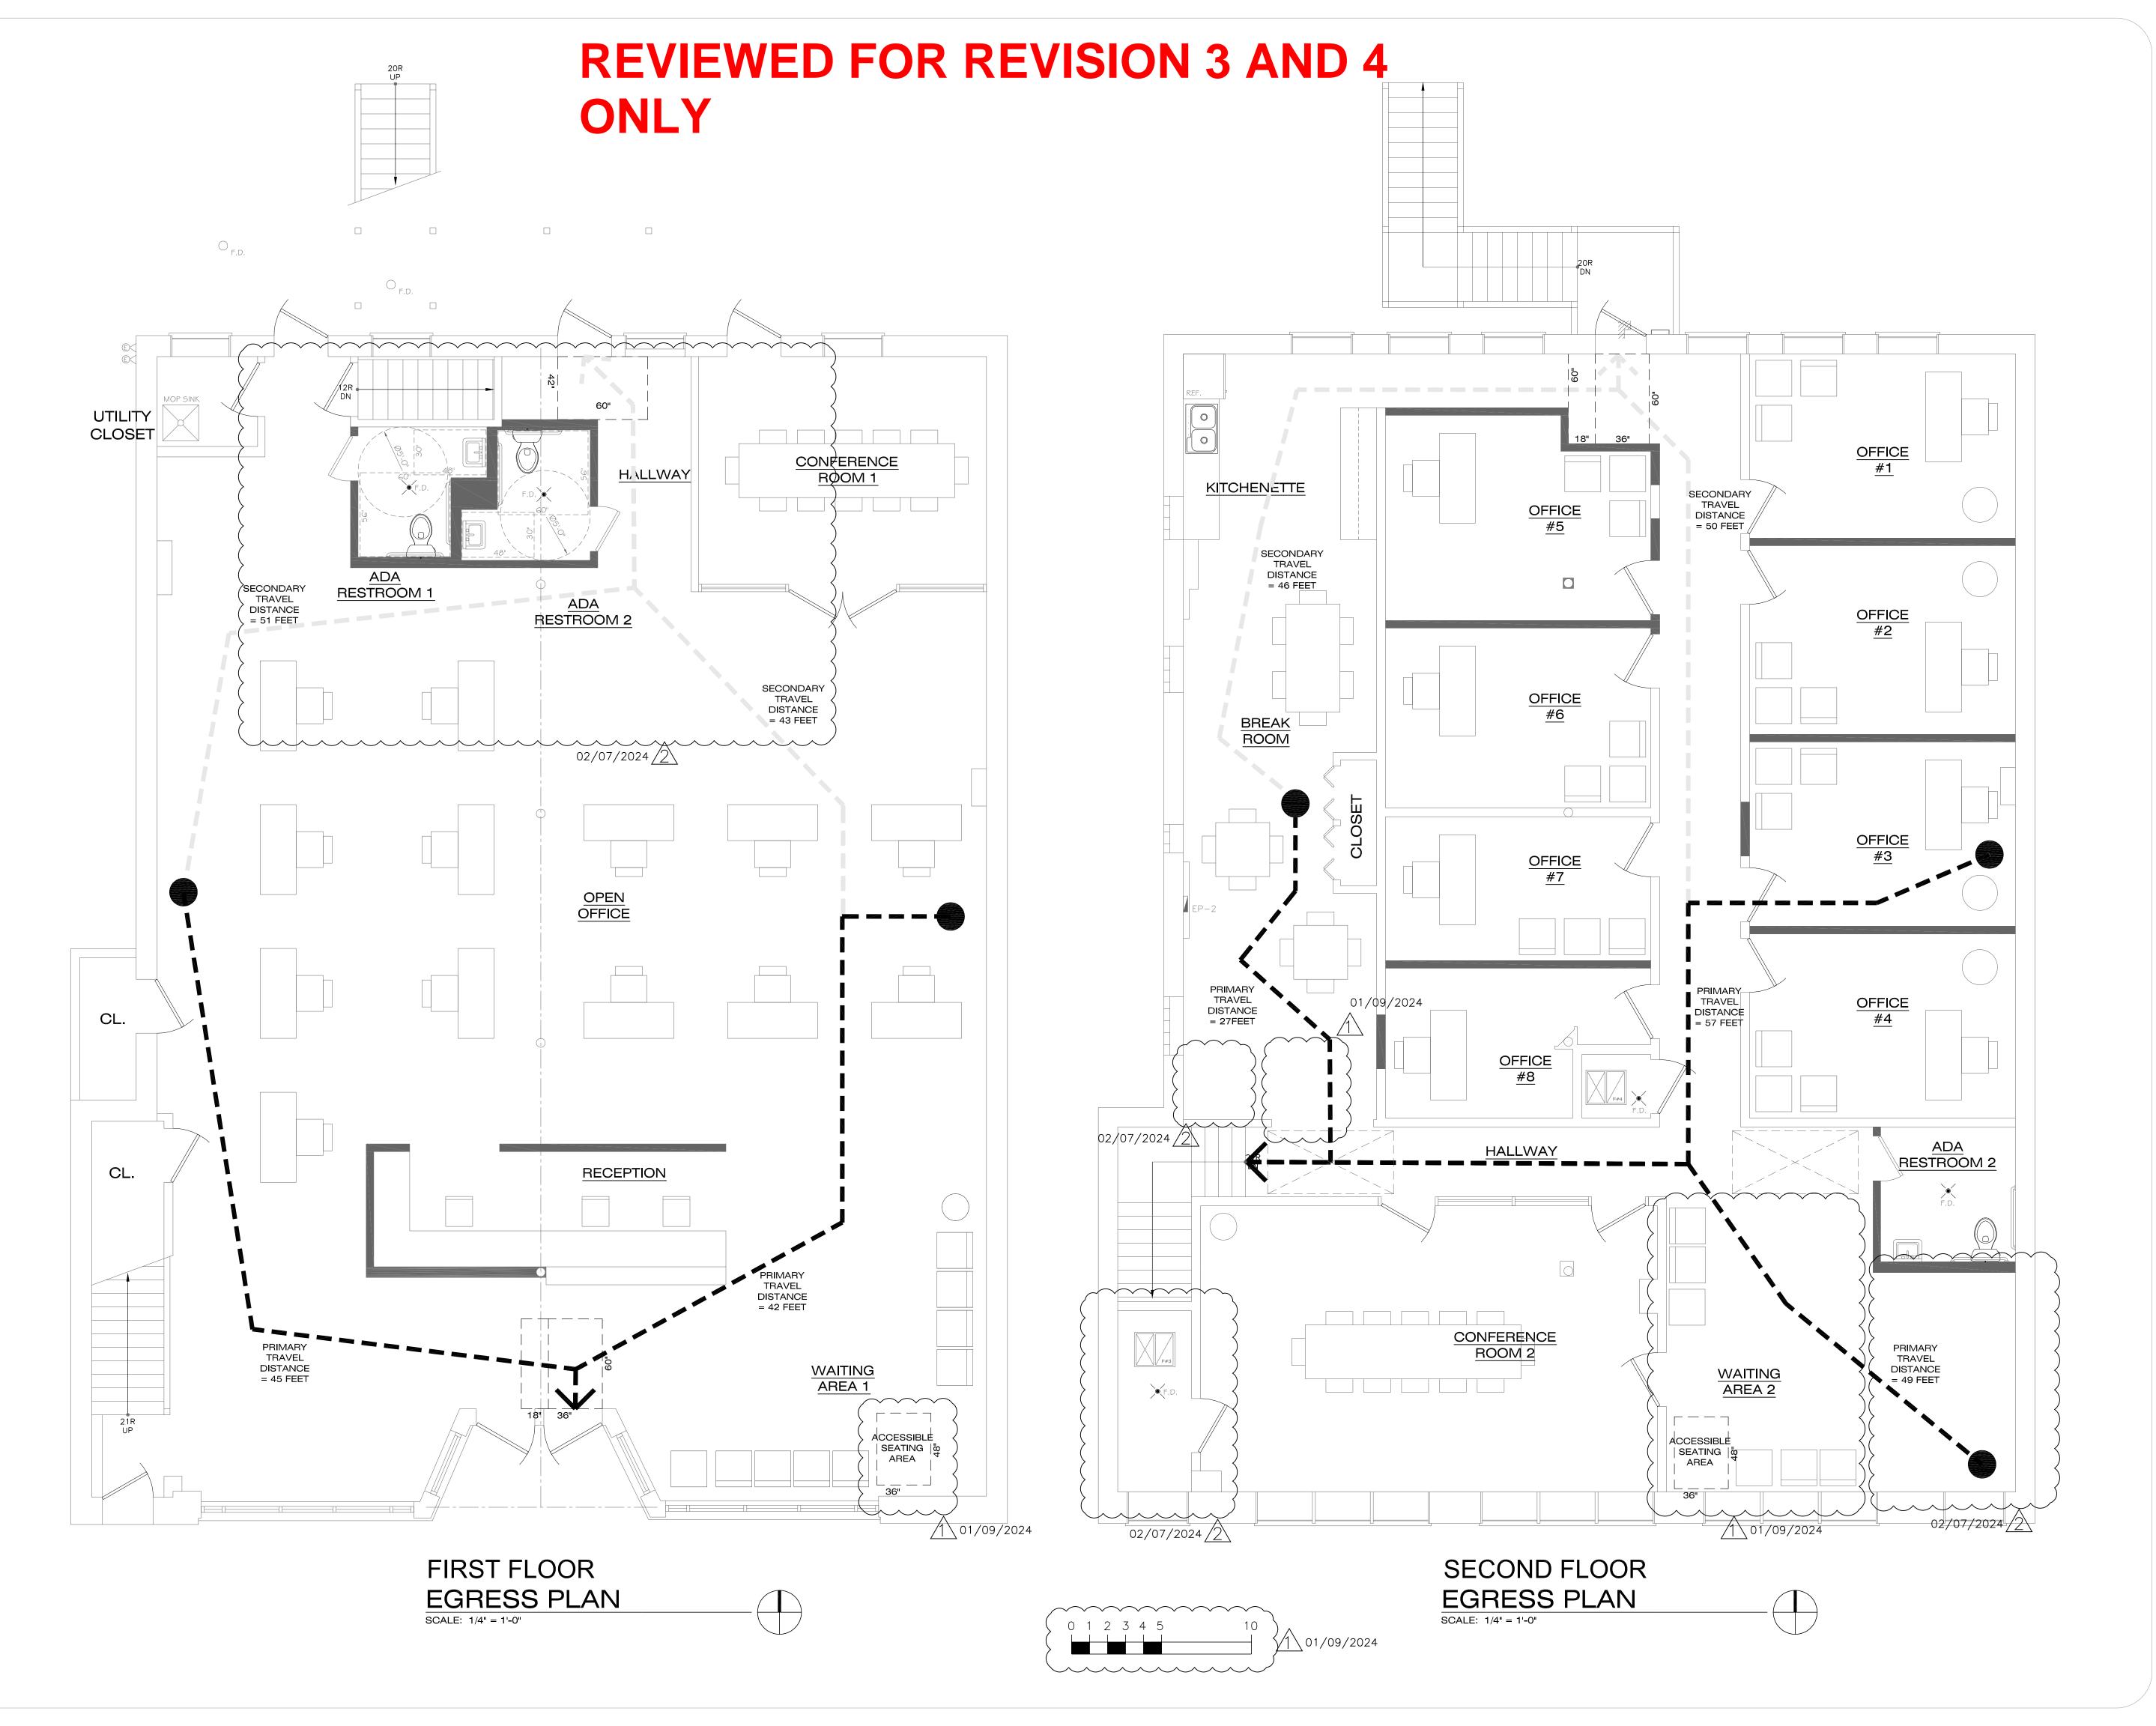
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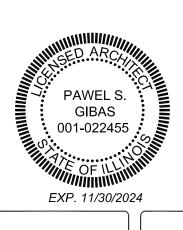
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**PROPOSED PLANS** 



**REVISIONS:** <u>^</u> 02/07/2024






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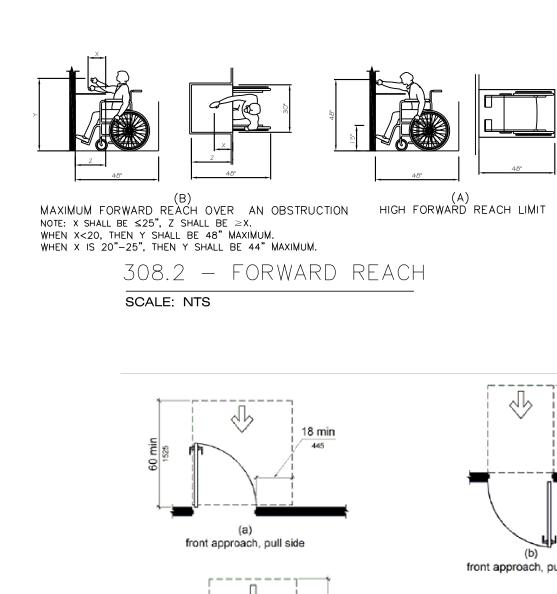
ROOSEVELT PARK IL 60304 6632 W. OAK


DRAWING TITLE:

**EGRESS PLANS** 

# **REVIEWED FOR REVISION 3 AND 4 ONLY**




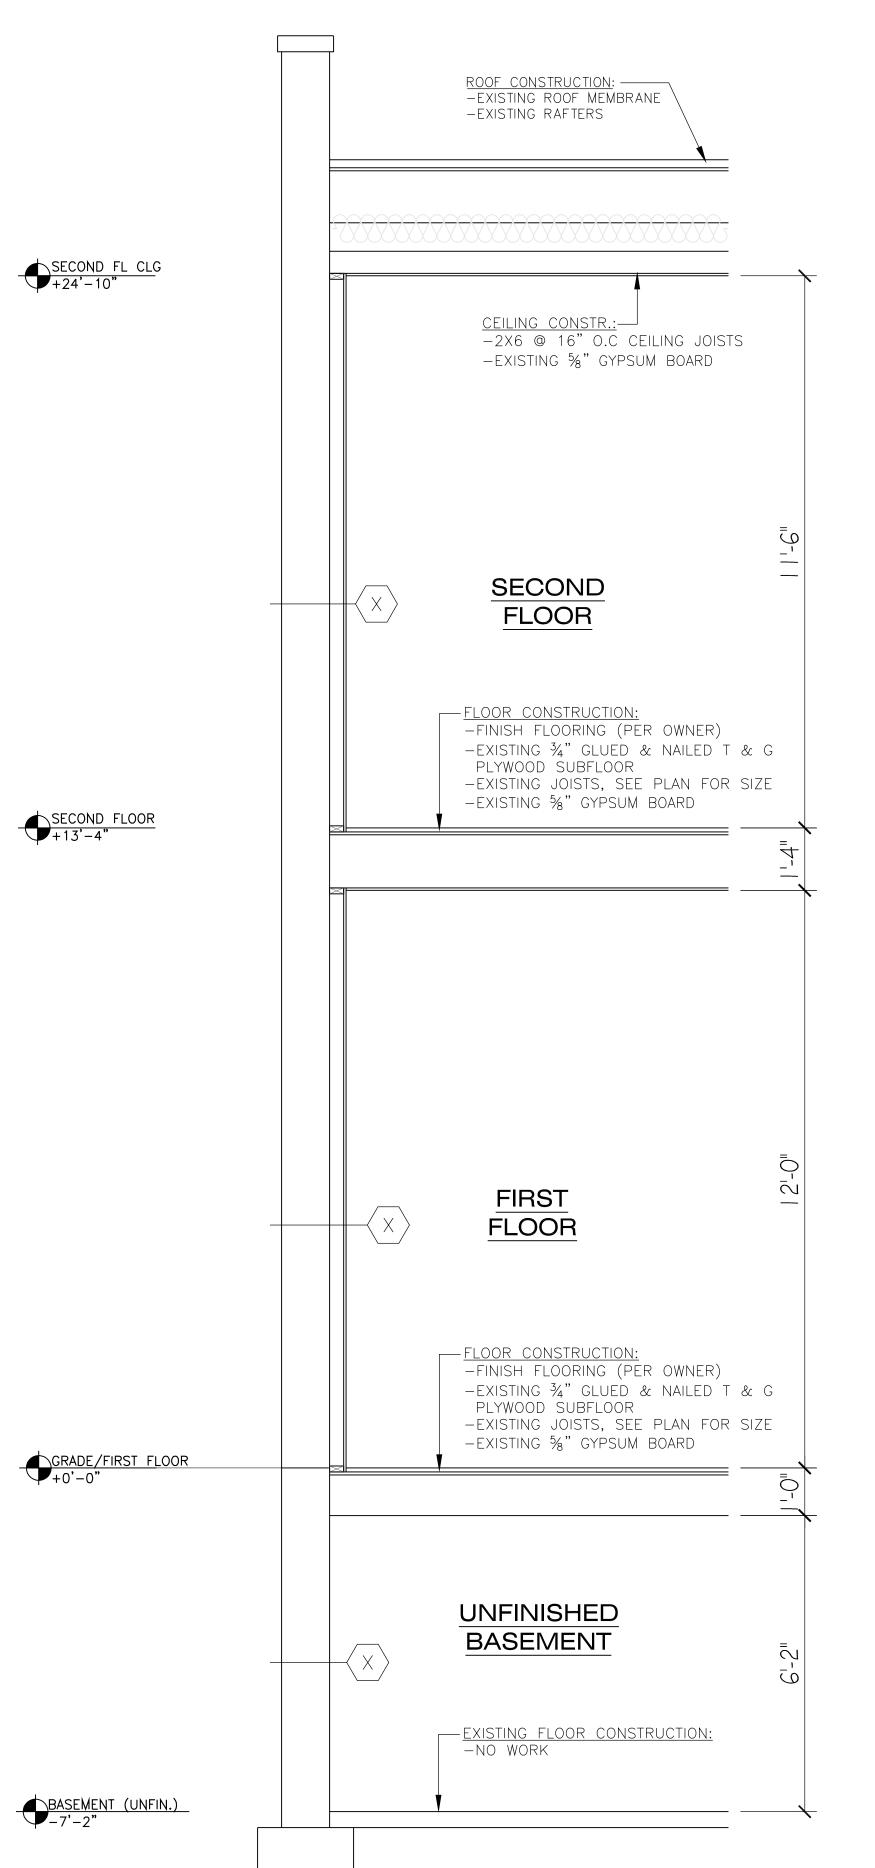


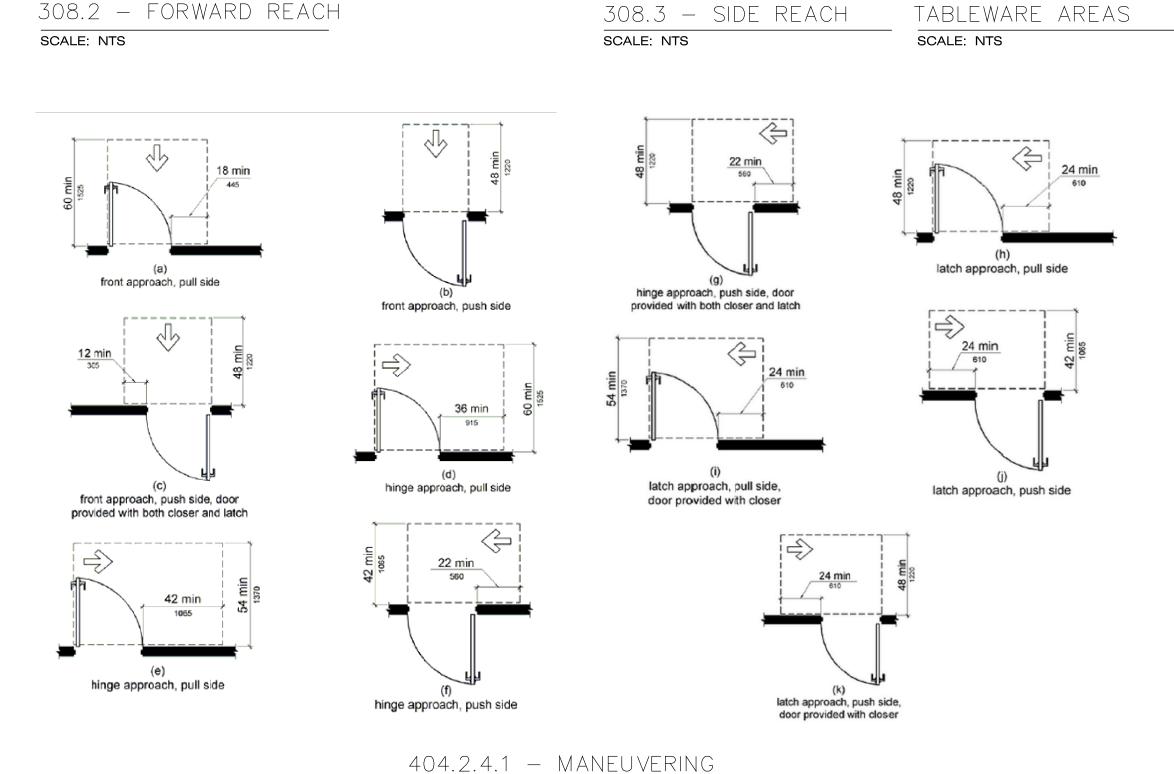

(A) (B)
CLEAR FLOOR SPACE HIGH AND LOW
- PARALLEL APPROACH SIDE REACH LIMITS

(C) MaxiMum Side Reach Over an obstruction

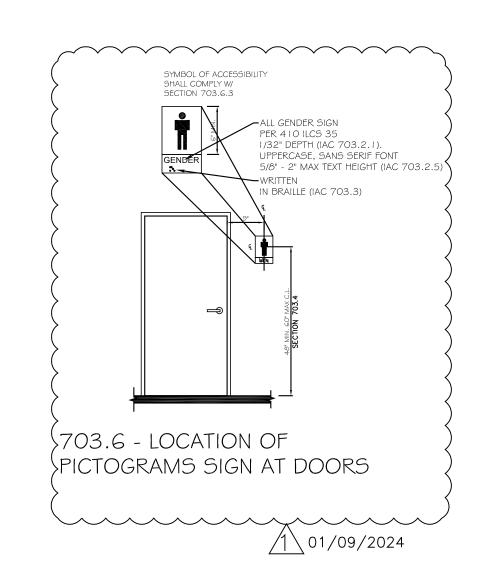


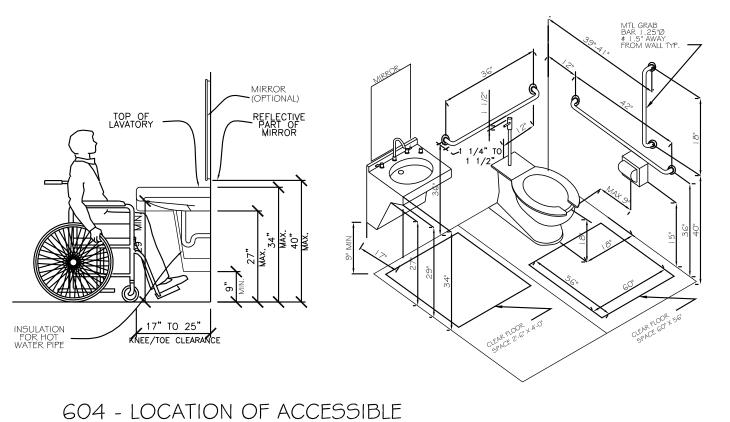


FIXTURES AND ACCESSORIES

CLEARANCE AT DOORS

SCALE: NTS

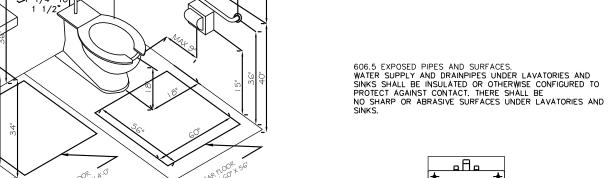

606.5 - EXPOSED PIPES AND SURFACES.

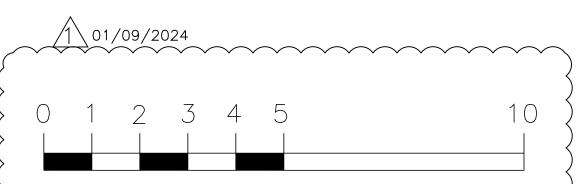


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BUILDING SECTION (1

**REVISIONS:** 109/2024

CONSTRUCTION DOCUMENT(S) REVIEWED FOR COMPLIANCE



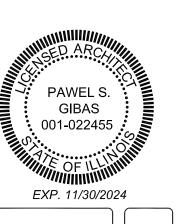

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DRAWING TITLE:

**SECTION** AND

**DETAILS** 

**REVIEWED FOR REVISION 3 AND 4** 


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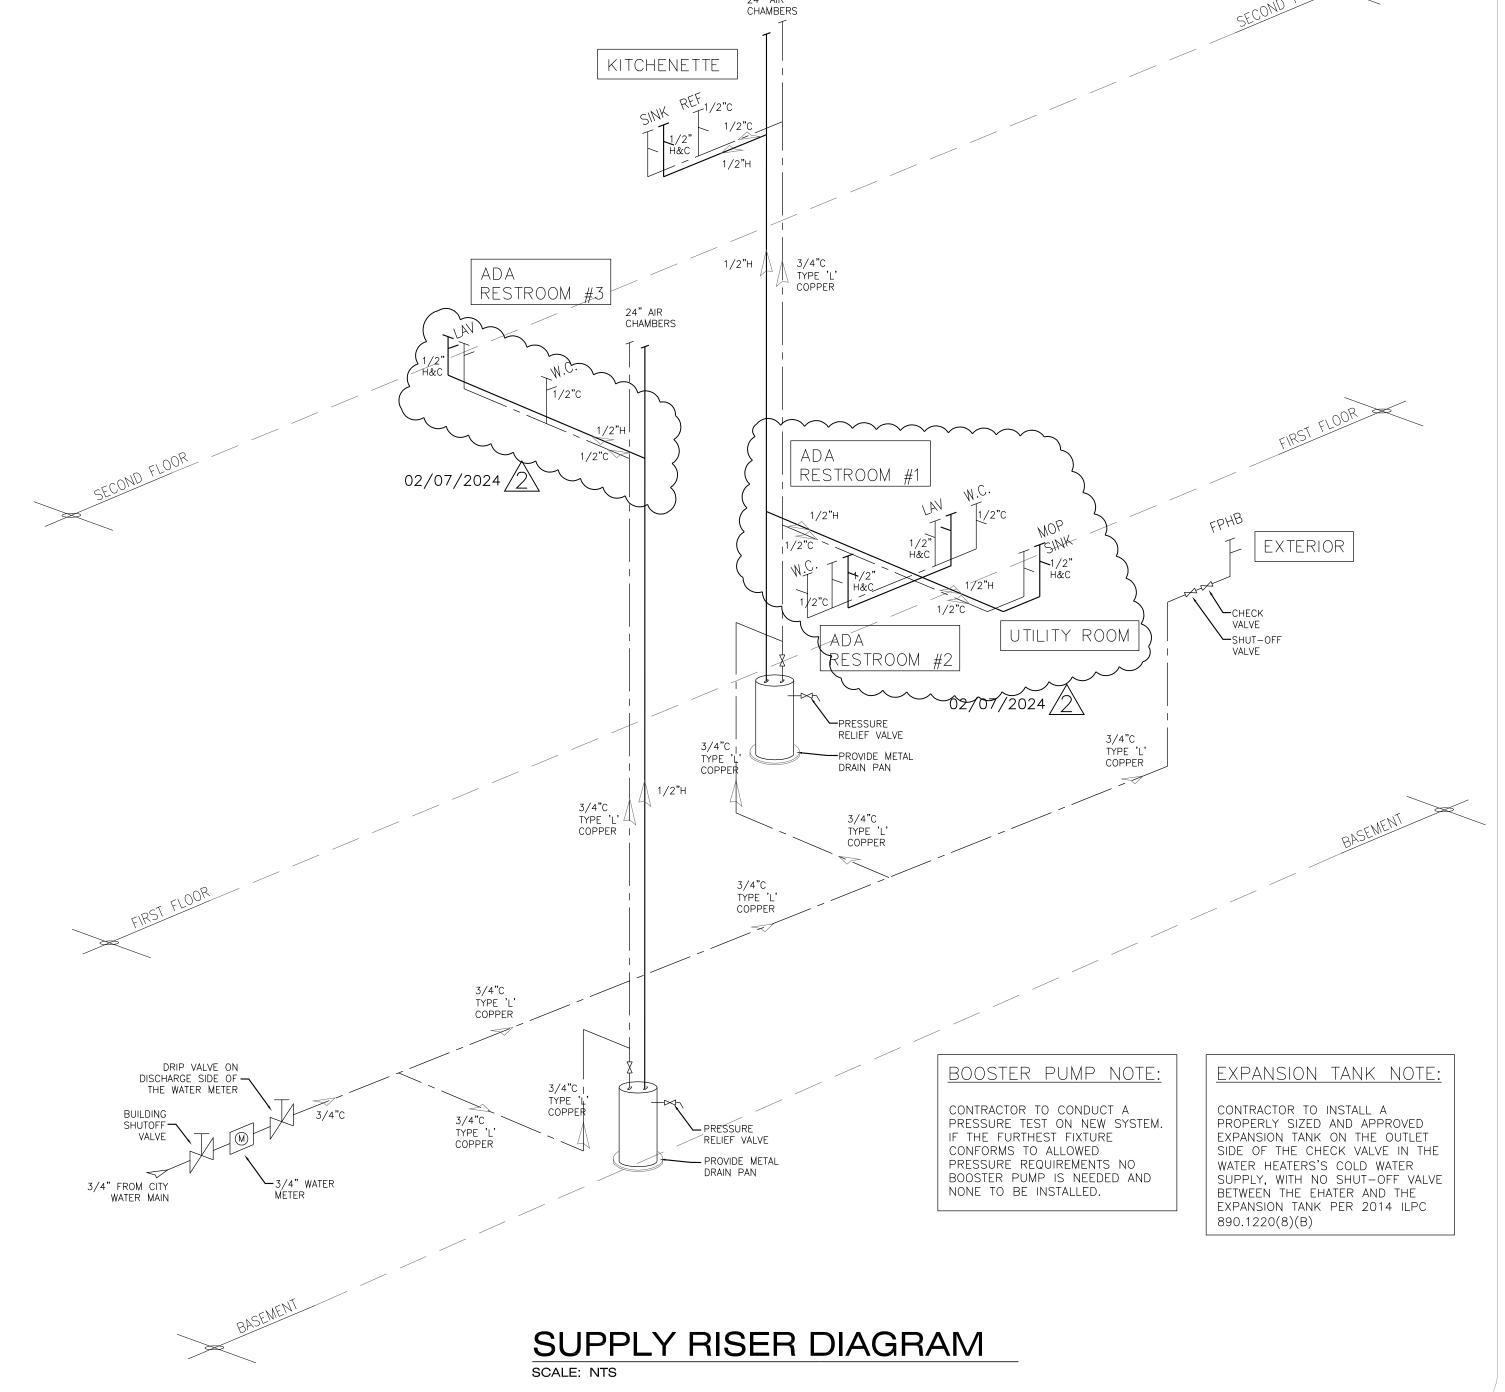
COMM	COMMERCIAL FLUIDING FIXTURE SCREDULE						
WATER CLOSET	3	AMERICAN STANDARD	<u>CERAMIC</u>				
LAVATORY	3	AMERICAN STANDARD	CERAMIC				
KITCHEN SINK	1	AMERICAN STANDARD	STAINLESS STEEL				
MOP SINK	1	SPECIFIED BY OWNER					
FLOOR DRAIN  WADE NO. W-1100 WITH STANDARD POLISHED NICKEL BRASS STRAINER (OR EQUIVALENT FROM OTHER MFR.)							

PLUMBING LEGEN	D
	WASTE LINE
	VENT LINE
	COLD WATER
	HOT WATER

#### PLUMBING NOTES:

- 1. ALL PLUMBING WORK MUST BE PERFORMED BY LICENSED CONTRACTOR AS REQUIRED BY 2014 ILLINOIS PLUMBING CODE.
- 2. PLUMBING CONTRACTOR SHALL OBTAIN ALL REQUIRED BONDS AND PAY ALL FEES AND TAXES FOR NECESSARY PLUMBING PERMITS.
- 3. FURNISH AND INSTALL COMPLETE DRAIN AND SEWER SYSTEM. HOUSE SEWER AND DRAINPIPES SHALL BE CAST IRON SOIL PIPE OR PVC.
- 4. FURNISH AND INSTALL SOIL, WASTE AND VENT PIPES AS REQUIRED. ALL ABOVE GROUND SOIL STACKS, WASTE STACKS, VENT PIPES AND FITTINGS TO BE CAST IRON
- 5. ALL TRAPS SHALL BE SELF-CLEANING.
- 6. FURNISH AND INSTALL COMPLETE AND OPERABLE SYSTEM OF COLD AND HOT WATER TO EACH AND EVERY PLUMBING FIXTURE, APPLIANCE OR MECHANICAL EQUIPMENT REQUIRING WATER. INSTALL AS REQUIRED BY CODE PIPEFITTING, VALVES AIR C CHAMBERS DI-ELECTRIC UNIONS HANGERS, ETC. INSTALL ALL PLUMBING FIXTURES, COMPLETE WITH TRAPS, STOPS, HANGERS AND ALL RELATED ITEMS AS REQUIRED.
- 7. INSULATE ALL HOT AND COLD WATER PIPING NOT IN PLUMBING CHASE WITH  $\frac{1}{2}$ " FIBERGLASS INSULATION. ALL PIPING IN EXTERIOR WALLS OR IN SUSPENDED, UNHEATED SPACES SHALL HAVE 1" MIN. THICK INSULATION.
- 8. DOMESTIC HOT AND COLD WATER PIPING ABOVE THE GRADE SHALL BE TYPE "L" COPPER. (TYPE "K" UNDERGROUND) INSTALL DI-ELECTRIC UNIONS AT DISSIMILAR
- A. 24" AIR CHAMBER AT ALL RISER MAINS.
- B. 12" AIR CHAMBER AT ALL PLUMBING FIXTURES. C. SHUT OFF VALVES AT ALL PLUMBING FIXTURES AND D. NON-FREEZE SILL COCKS - VACUUM BREAKER TYPE 2.
- 10. ROOF VENTS SHALL EXTEND A MINIMUM OF 12" ABOVE ROOF.
- 11. THE PLUMBER UNDER EITHER A WATER OR AIR PRESSURE METHOD SHALL TEST THE ENTIRE PLUMBING SYSTEM.
- 12. THE PLUMBING CONTRACTOR SHALL DISINFECT THE ENTIRE WATER SERVICE SUPPLY SYSTEM BEFORE SYSTEM OPERATION.
- 13. THE DRAIN AND SEWER SHALL BE ROOT PROOF AND WATER TIGHT AND TESTED WITH A MIN. TEN (10) FOOT WATER COLUMN.
- 14. FURNISH AND INSTALL GAS PIPING WITH SHUTOFF COCKS AT EACH AND EVERY APPLIANCE REQUIRING GAS, INCLUDING FURNACE, WATER HEATERS, ETC. PIPING SHALL BE SCHEDULE 40 BLACK STEEL, "GRADE A" FITTINGS SHALL BE STANDARD WEIGHT, BLACK MALLEABLE IRON OR CAST IRON SCREENED AND RATED AT 150 PSI.
- 15. PROVIDE WATER MIXING DEVICE AT HAND-HELD SPRAY.



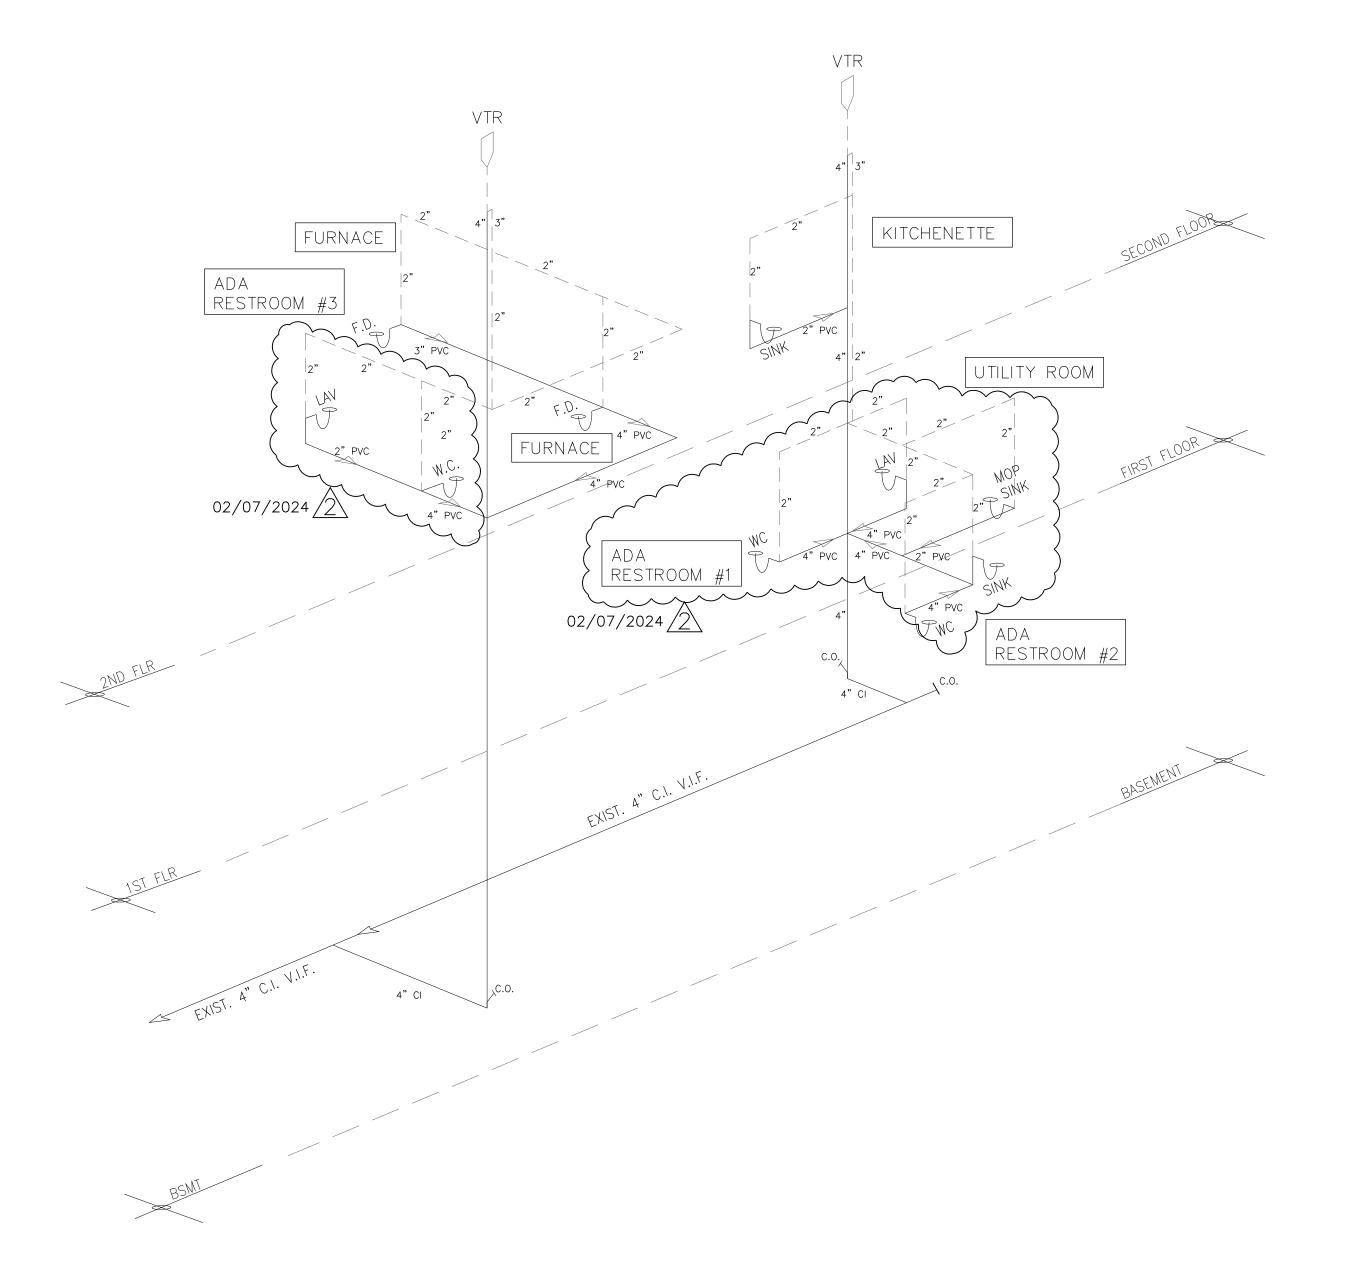


CONSTRUCTION DOCUMENT(S) **EVIEWED FOR COMPLIANCE** 

<u>2</u> 02/07/2024

**REVISIONS:** 



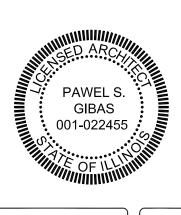


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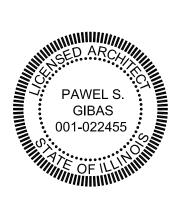
6632 W. OAK

DRAWING TITLE:

**PLUMBING DIAGRAMS** & NOTES

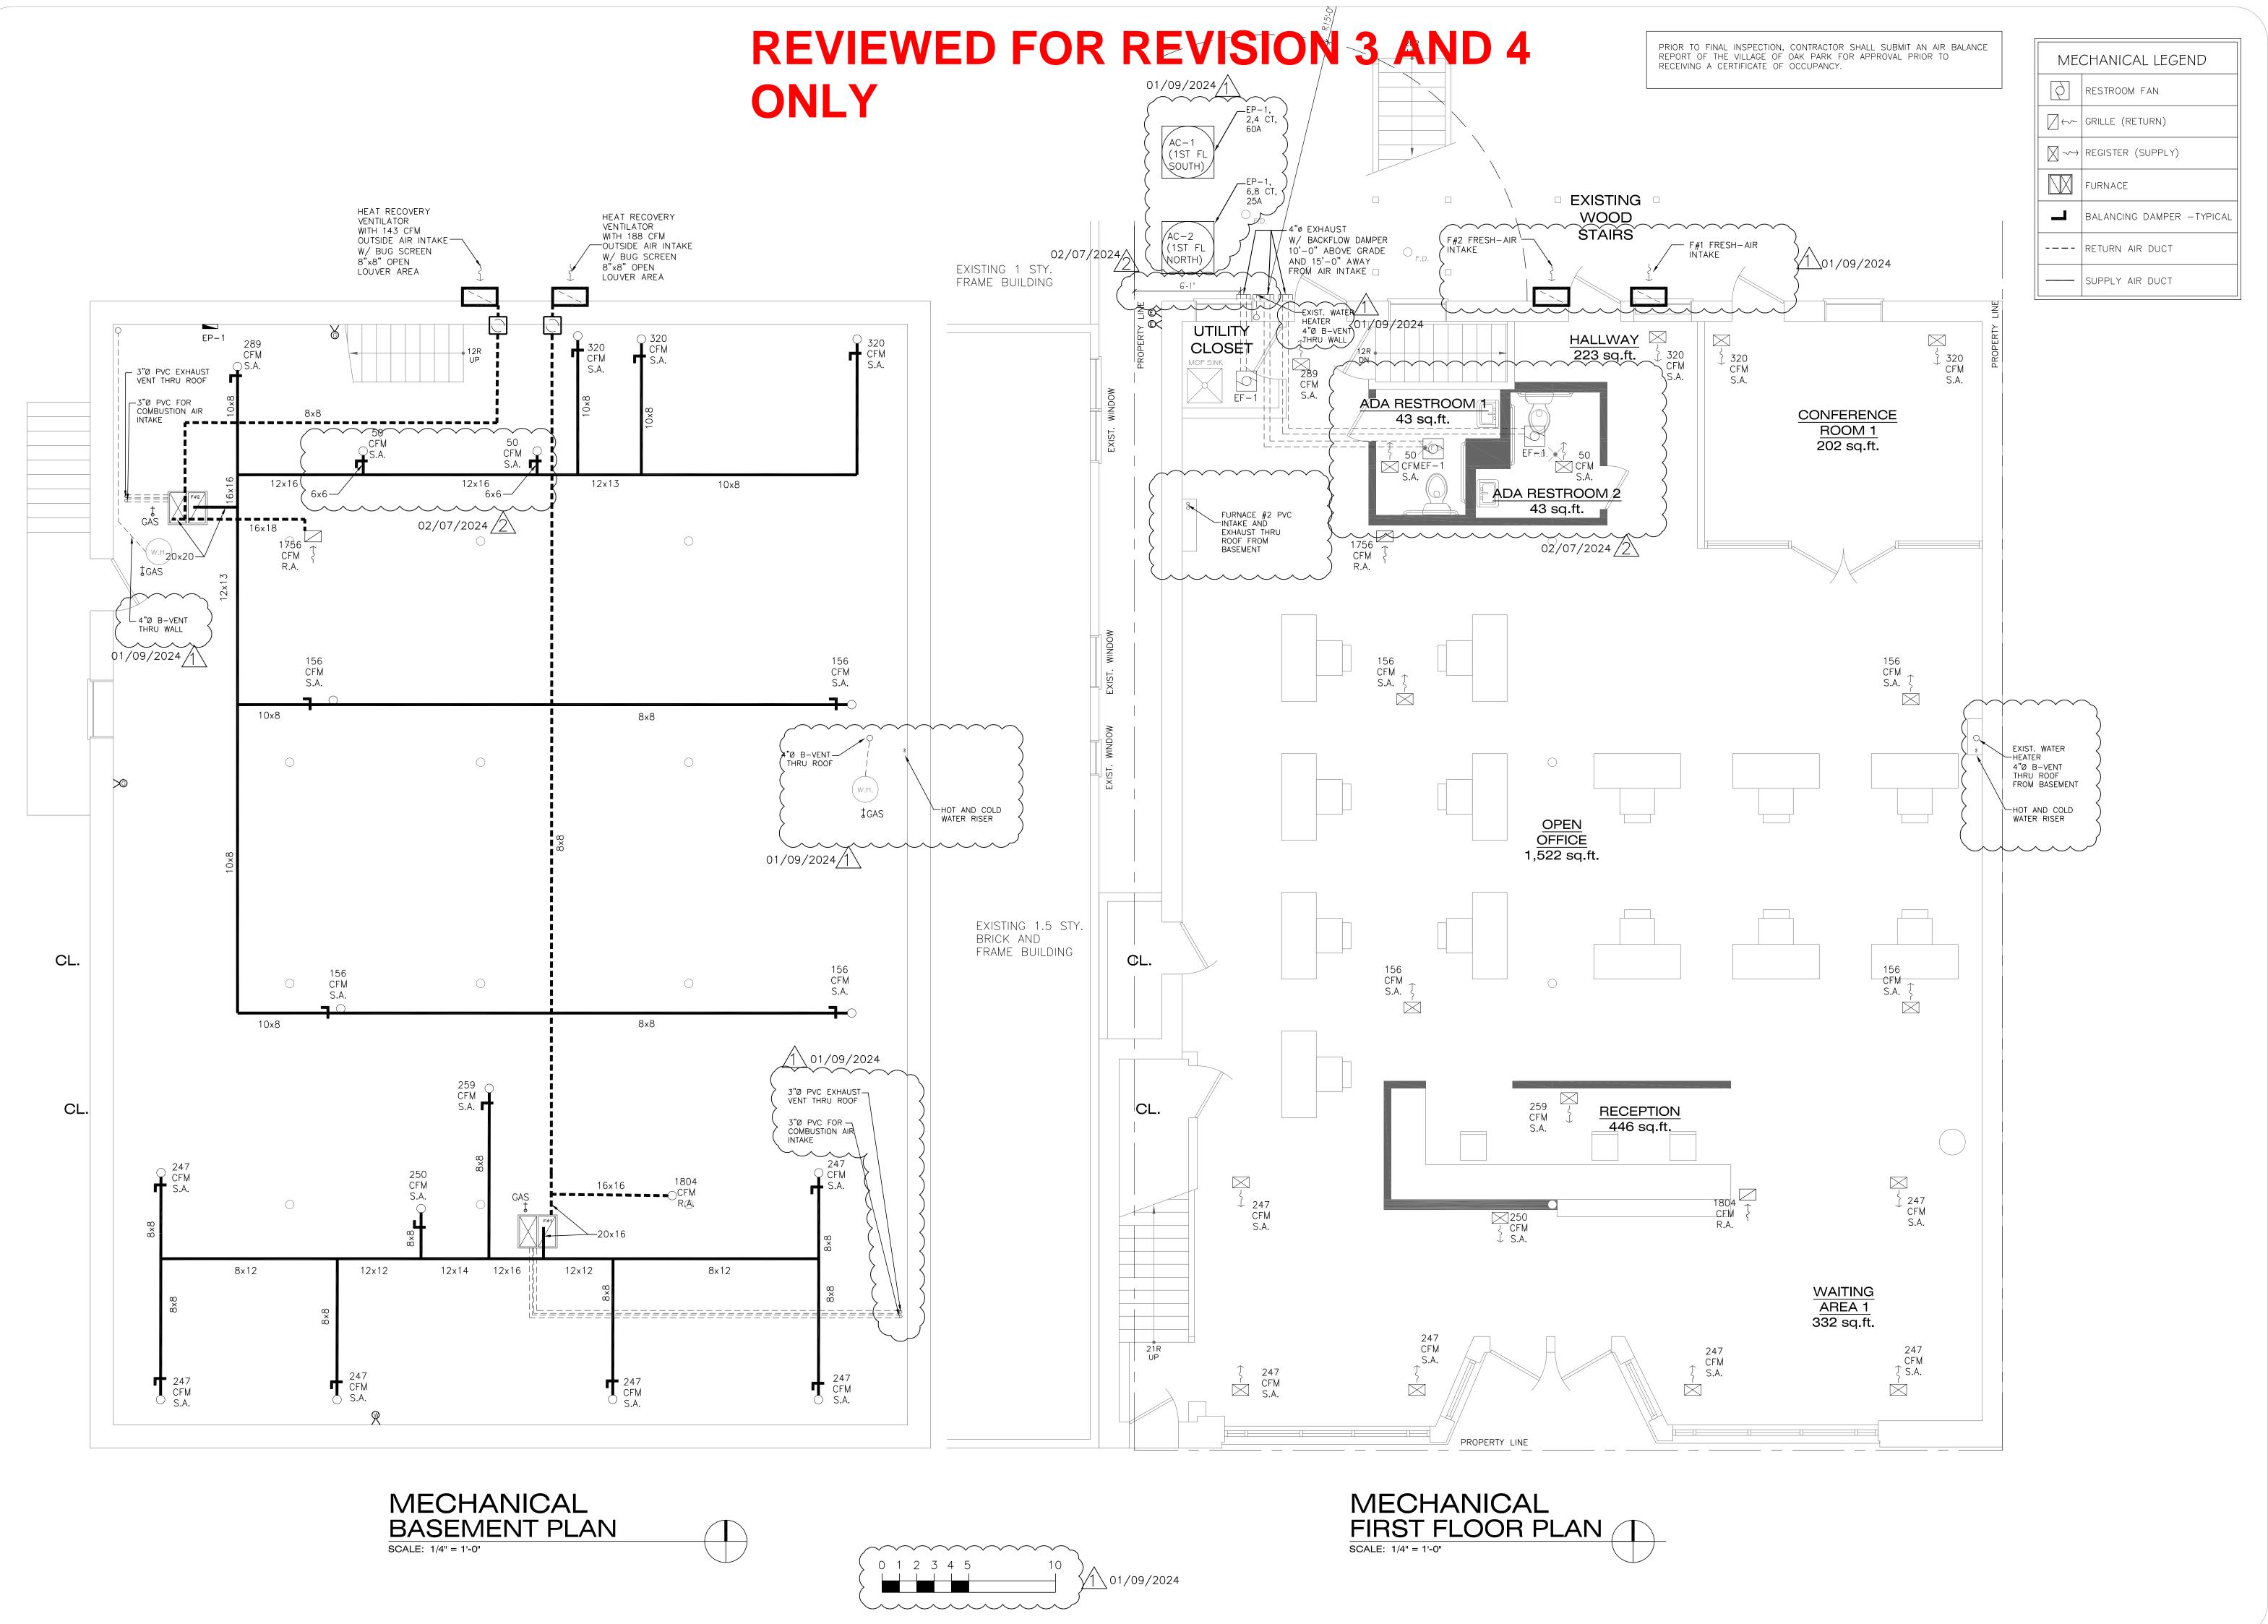


CONSTRUCTION DOCUMENT(S)





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ROOSEVELT PARK IL 60304 6632 W. OAK

DRAWING TITLE: **MECHANICAL PLANS** 




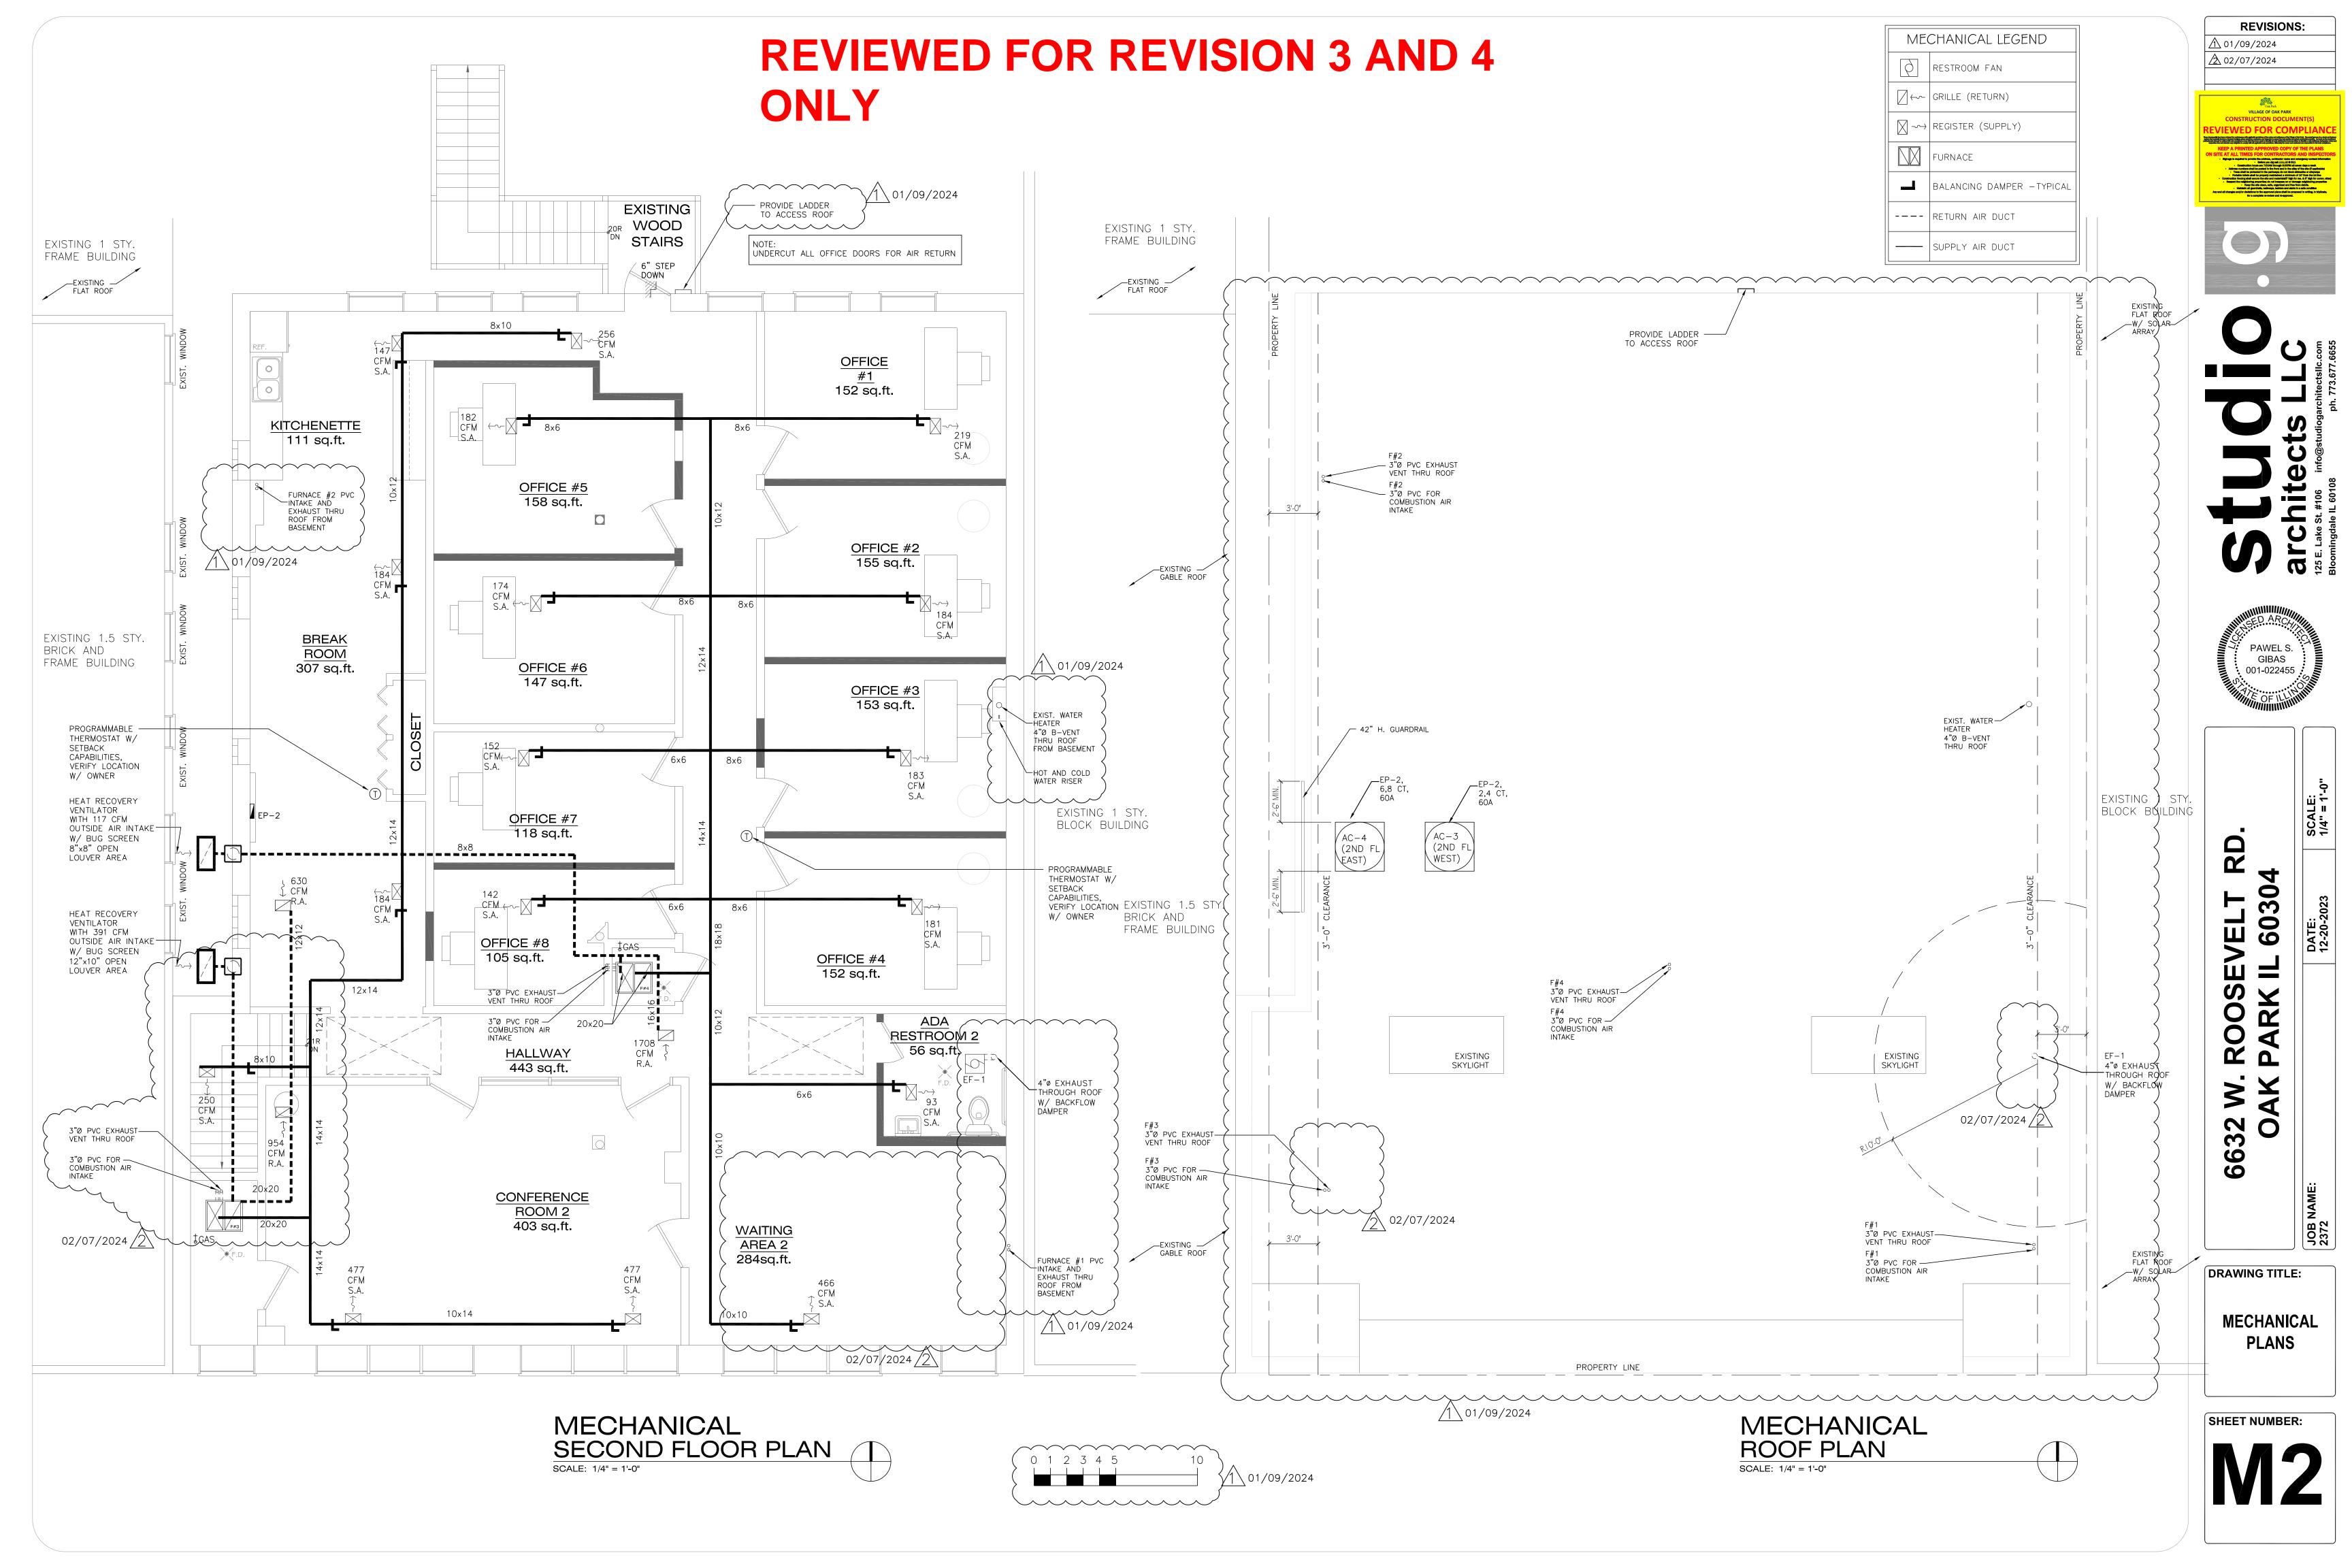

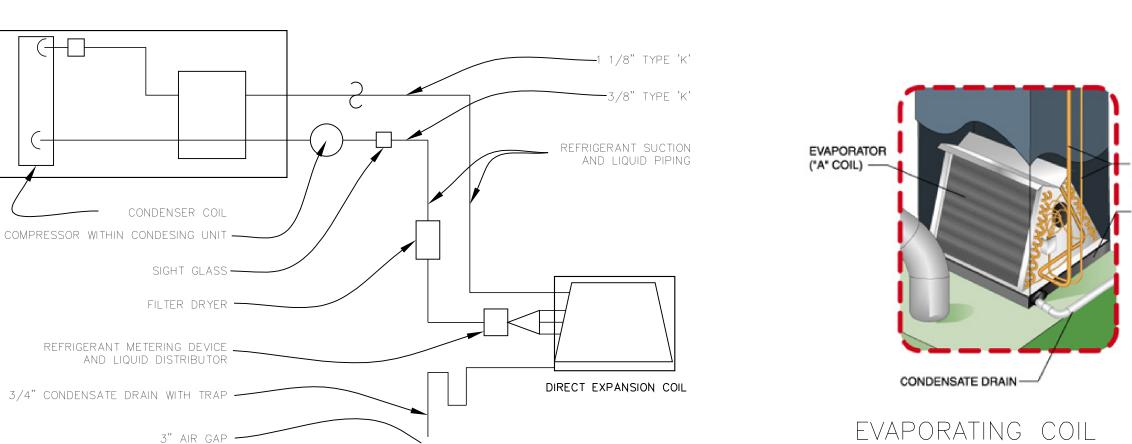

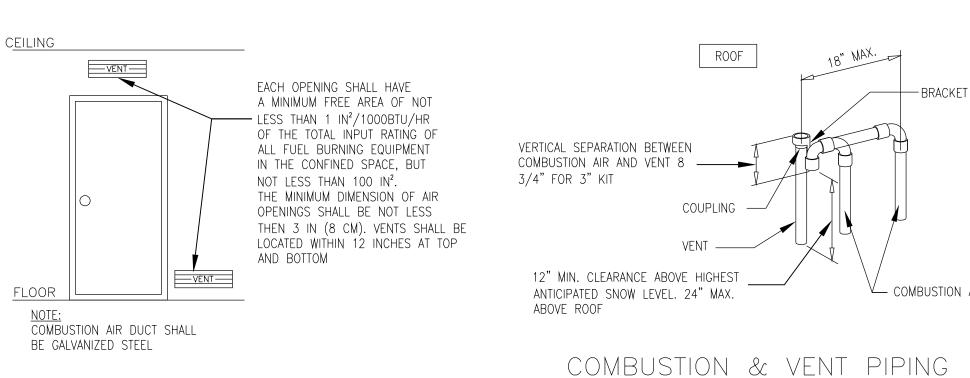

CONDENSOR DIAGRAM

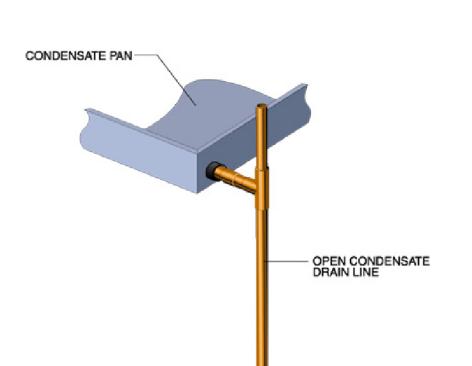

OPEN-LEG CONDENSATE DRAIN LINE SCALE: NTS


- MECHANICAL NOTES 1. ALL WORK TO BE PERFORMED BY A ... INSIDE TWACK ON THAT INC. A COMPLEX BLACK PLANT BALANCE R.L. AIR THAT DLI G. SYST W.S. A ID. GLANT CERTIFICATION COMPLEX WITH JULINOIS AMENDMENTS.

  1. ALL WORK TO BE PERFORMED BY A ... INSIDE TWACK ON THAT WILL GET THE WORK ON THAT VILL GET THE WORK OF THE WORK OF THE WORK.

  2. ADDITIONAL THAT WORK OF THE WORK. 1. ALL WORK TO BE PERFORMED
- 2. THE HVAC CONTRACTOR IS TO OBTAIN
- 3. FURNISH ARCHITECT WITH COMPLET SHOWING AND CUTS, SHOWING DUCT CONNECTIONS, SIZES, AIR QUANTITIES AND REGISTERS INCLUDING MECHANICAL EQUIPMENT, EXHAUST FANS ETC. FOR APPROVAL BEFORE BEGINNING ANY WORK. 4. FURNISH AND INSTALL COMPLETE AND OPERABLE HVAC SYSTEM AS INDICATED: SYSTEMS ARE TO HEAT THE BUILDING TO 70 F AT -10 F OUTSIDE TEMPERATURE.
- EACH SYSTEM IS TO BE SIZED AS TO DELIVER 500 CFM MINIMUM, WITH DOWN SIZED BELT DRIVEN MOTOR. EACH SYSTEM IS TO BE FITTED WITH ELECTRONIC AIR FILTER AND HUMIDIFIER CAPABLE OF MAINTAINING 40% RH. EACH FURNACE SHALL BE OF ENERGY EFFICIENT DESIGN WITH ELECTRONIC CONTROLS AND SPARK IGNITION, 100% SAFETY SHUT-OFF VALVE L.P. REGULATOR AND SHUT-OFF VALVE. COORDINATE LOCATION OF THERMOSTATS WITH OWNER.
- 5. FRESH AIR INTAKES MUST BE A MINIMUM OF 15 FT. AWAY FROM ANY EXHAUST OUTLET.
- 6. VENT & DUCT LINES TO BE 26 GA. GALVANIZED SHEET MTL. AND CONSTRUCTED IN ACCORDANCE WITH SMACNA STANDARDS.
- 7. REINFORCE AND BRACE ALL DUCTWORK SECURELY TO PREVENT VIBRATION AND. ALL 18. PROVIDE TWO PERMANENT OPENINGS FOR COMBUSTION AIR ONE HIGH AND ONE DUCTS TO BE INSTALLED IN STRICT ACCORDANCE WITH ASHRAE GUIDELINES. 8. PROVIDE INDIVIDUAL MANUAL SPLITTER DAMPERS IN ACCESSIBLE LOCATIONS FOR
- BALANCING THE SYSTEM. ALL DAMPERS TO BE LOCKING TYPE. 9. INSULATE ALL DUCTWORK LOCATED IN UNCONDITIONED SPACES WITH 1" THICK
- FIBERGLASS INSULATION AND VAPOR BARRIER JACKET. 10. INSULATE ALL COMBUSTION AIR DUCT WORK WITH 1" THICK FIBERGLASS INSULATION AND VAPOR BARRIER.
- 11. CAREFULLY COORDINATE LOCATION OF DUCTWORK WITH STRUCTURAL FRAMING. ANY CUTTING REQUIRED MUST BE DONE BY A SKILLED CARPENTER UNDER THE DIRECTION OF THE GENERAL CONTRACTOR.

  - 27. ALL VENTS TO PROJECTS 2'-0" ABOVE PARAPET WITH 10' RADIUS


EVAPORATING COIL SCALE: NTS

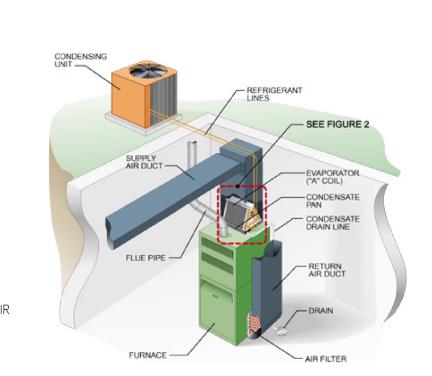

DIAGRAM

SPLIT AIR CONDENSING SYSTEM

TERMINATION DTL.

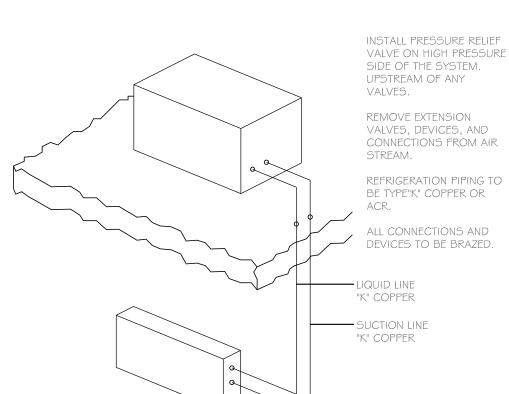

(6)

REMOTE REFRIGERATION PIPING DIAGRAM SCALE: NTS

13. FURNISH AND INSTALL COMPLETE AND OPERABLE SYSTEM OF VENTILATION AND EXHAUST AS REQUIRED AND INDICATED ON DRAWINGS FOR RESTROOM APPLIANCES. PROVIDE WALL CAP, BUG SCREEN AND GRAVITY DAMPERS.

14. ALL FLUES FOR GAS FURNACES AND WATER HEATERS SHALL BE TYPE "B". FLUES THAT PENETRATE THE ROOF SHALL EXTEND A MINIMUM OF 3 FEET ABOVE THE HIGHEST POINT OF THE ROOF OR ADJACENT ROOF, AND MUST BE DOUBLE WALL CONSTRUCTION - 14 GA. STEEL OR AS REQUIRED BY CODE. FLUES MUST BE PROVIDED WITH A VENTILATING ROOF THIMBLE THAT PROVIDES 2" MINIMUM CLEARANCE ALL AROUND. SUCH THIMBLE WILL EXTEND A MINIMUM OF 6" ABOVE AND BELOW THE ROOF.

15. THE A/C CONDENSER MUST BE SET ON A PREFABRICATED BASE, AND LOCATED TO ALLOW FREE AIR FLOW.

16. PRODUCT INFORMATION SHEET FOR HEATING AND/OR COOLING SYSTEM TO BE ON SITE AT TIME OF INSPECTION. 17. ALL RETURNS ARE TO BE DUCTED, USE OF WALL CAVITY FOR RETURN AIR IS

PROHIBITED

19. LOCATION OF PRESSURE RELIEF DEVICE MAY NOT BE LOCATED IN ANY SPACE CONTAINING MOVING OBJECTS.

20 REFRIGERANT LINES MAY NOT BE LOCATED IN ANY SPACES CONTAINING MOVING OBJECTS OR IN STAIRWELLS OR OTHER MEANS OF EXIST. NOT PERMITTED UNDER STAIRS, FIRE ESCAPES OR HALLWAYS. 21. LOCATION OF OUTLETS MUST CONFORM TO 2018 IFGC 404.13

( 22. PIPING IN CONCEALED LOCATIONS MUST CONFORM TO 2018 IFGC 404.13 PRESSURE REGULATORS REQUIRING VENTS MUST HAVE AN INDEPENDENT VENT TO

THE OUTSIDE OF THE BUILDING. 24. GAS PIPING MATERIALS MUST CONFORM TO THE GAS PIPING AND TUBING MATERIAL

MATRIX (2018 IFGC 403 REQUIREMENTS). 01/09/2024 (25. Gas pipes must be sloped at  $\frac{1}{4}$ " in every 15'-0".

> 26 FUEL GAS PIPING AND CONTROLS MUST CONFORM TO THE INTERNATIONAL 2018 FUEL GAS CODE (IFGC), CHAPTER 4 (WITH MODIFICATIONS AS NOTED IN ARTICLE 14.

28. MAXIMUM DESIGN OPERATING PRESSURE FOR GAS PIPING SYSTEM LOCATED INSIDE BUILDINGS SHALL NOT EXCEED 5 PSIG.

 $\$ 29. VENTING OF ALL GAS FIRED APPLIANCES MUST CONFORM TO 2018 INTERNATIONAL 30. VENTS MUST TERMINATE 2 FEET ABOVE THE HIGHEST PORTION OF THE ROOF THAT IS WITHIN 10 FEET OF THE VENT ..

-CONDENSATE PAN 31. INSTALL PRESSURE RELIEF VALVES ON THE HIGH PRESSURE SIDE OF THE SYSTEM, UPSTREAM OF ANY INTERVENING VALVES.

32. COLLECT AND DISCHARGE CONDENSATE TO FLOOR DRAIN.

33. CONDENSATION PROTECTION IS REQUIRED WHEREVER CONDENSATION MAY BE EXPECTED TO OCCUR ON PIPING WHICH COULD CAUSE A SAFETY HAZARD TO OCCUPANTS, STRUCTURE, EQUIPMENT, ETC.

02/07/2024/2

IN	<b>1</b> 4	FUR	NACE SC	HEDULE	
VBOI	MODEL NAME	A =   1 =	LOCATION	BTUH	
VIDOL	MODEL NAME	AIUL	LOCATION	INPUT	
	RHEEM				

SYMBOL	MODEL NAME	AFUE	LOCATION DIUT		CFIVI		
	MODEL NAME	AIUL	LOCATION	INPUT	OUTPUT	HEATING	COOLING
FI	RHEEM R92T0851521 (OR EQUIVALENT)	92%+	MECH. RM.	84,000	77,0.00	1476	1974
F2	RHEEM R92T0851521 (OR EQUIVALENT)	92%+	MECH. RM.	84,000	77,000	1476	1974
F3	RHEEM R92T1001521 (OR EQUIVALENT)	92%+	MECH. RM.	98,000	9,0000	1558	1975
F4	RHEEM R92T1001521 (OR EQUIVALENT)	92%+	MECH. RM.	98,000	9,0000	1558	1975

	REFRIGERATION SCHEDULE								
SYMBOL	MODEL NAME	COMP. TON	LOCATION	REFRIGERANT	REMOTE	SELF CONTAINED	AIR COOLED		
AC-1 (1ST FL SOUTH)	RHEEM WA1460 (OR EQUIVALENT)	5	GRADE	R-410A	YES	NO	YES		
AC-2 (IST FL NORTH)	RHEEM WA1430 (OR EQUIVALENT)	2.5	GRADE	R-410A	YES	NO	YES		
AC-3 (2ND FL WEST)	RHEEM WA1460 (or equivalent)	5	ROOF	R-410A	YES	NO	YES		
AC-4 (2ND FL EAST)	RHEEM WA1460 (OR EQUIVALENT)	5	ROOF	R-410A	YES	NO	YES		
	01/09/2024								

<u> </u>						
EXHAUST FAN SCHEDULE						
SYMBOL	MODEL NAME	CFM	LOCATION	FAN RPM's	HP	NOTES
EF-1	BROAN 684 (or equivalent)	75	RESTROOM	540	77 WATTS	4"Ø EXHAUST DUCT

	WATER HEATER SCHEDULE							
SYMBOL	QUANT.	MODEL NAME	LOCATION	BUTH	NOTES			
WH	2	EXISTING BW RG240T6N	BASEMENT	40,000 BTU/HR INPUT	40 GAL			

	AIR BALA	NCE SCHE	DULE FI	
ROOM NAME	EXHAUST AIR FROM ROOM	RETURN AIR FROM ROOM	OUTDOOR AIR SUPPLY	CFM SUPPL
RECEPTION	-	1804	108	809
WAITING AREA 1	-	1604	80	1483
TOTAL	-	1804+108	+80=1992	1992

AIR BALANCE SCHEDULE F2								
ROOM NAME	EXHAUST AIR FROM ROOM	RETURN AIR FROM ROOM	OUTDOOR AIR SUPPLY	CFM SUPPLY				
OPEN OFFICE	_		60	624				
CONFERENCE 1	-	1756	83	640				
HALLWAY 1ST	_		_	609				
RESTROOM UNISEX	75	0	-	101				
TOTAL	75	75+60+83+1756=1974		1974				

AIR BALANCE SCHEDULE F3									
ROOM NAME	EXHAUST AIR FROM ROOM	RETURN AIR FROM ROOM	OUTDOOR AIR SUPPLY	CFM SUPPLY					
CONFERENCE 2	-	954	158	954					
HALLWAY 2ND	_		_	506					
BREAK ROOM	-	630	233	368					
KITCHENETTE	_		-	147					
TOTAL		158+233+954+630=1975							

ROOM NAME	EXHAUST AIR FROM ROOM	RETURN AIR FROM ROOM	OUTDOOR AIR SUPPLY	CFM SUPPLY
OFFICE 1	_		8	219
OFFICE 2	-		8	184
OFFICE 3	_		8	183
OFFICE 4	-		8	181
OFFICE 5	_	1708	8	182
OFFICE 6	-	.,, 65	8	174
OFFICE 7	-		8	152
OFFICE 8	-		8	142
WAITING AREA 2	-		53	373
RESTROOM 2	75	0	_	93
RESTROOM 3	75	0	_	93
TOTAL	150	150+53+64	+1708=1975	1975

AIR BALANCE SCHEDULE F4

			VENTILATION SCHEDULE 1ST FLOOR													
ROOM DESC	RIPTION		(	ORDINANCE REQUIRE	MENTS			ACTU	AL PROVIDED			HEATING DATA	(-10° OUTSIDE	/ 70° INSIDE	<u> </u>	
		NATURAL LI (SQ.FT.)	GHT + VENT	ESTIMATED MAX. OCCUPANT LOAD,		MECH. VENT (CFM)	NATURAL L (SQ.FT.)	IGHT + VENT	MECH. VENT (CFM)	RETURN AIR	OUTDOOR	BASSIS OF HEAT LOSS	ORIDNANCE REQUIREMENT	ACTUAL	ACTUAL	
ROOM NAME	ROOM AREA (SQ.FT)	GLASS AREA (S.F. 8% FLOOR AREA	) VENT AREA (S.F.) 4% FLOOR AREA	PERSONS PER 1,000 SQ.FT.	PER MINUTE PER PERSON	EXHAUST AIR FROM ROOM	GLASS AREA (SQ.FT.)	VENT AREA (SQ.FT.)	EXHAUST AIR FROM ROOM	FROM ROOM	AIR SUPPLY	CALUCLATION	BTUH HEAT LOSS AT 100%	SUPPLY CFM AT 104°F	CFM SUPF AT 104°F	
$\parallel F-1/AC-1$												ASHRAE				
RECEPTION	446	ARTIFICIAL	MECHANICAL	14	14 x 7.5 = 105 CFM	0	0	MECHANICAL	_	1804	105	ASHRAE	20653	21,464	509	
WAITING AREA 1	332	ARTIFICIAL	MECHANICAL	10	10 x 7.5 = 80 CFM	0	232.5	MECHANICAL	-		80	ASHRAE	39209	62,536	1483	
												TOTAL:	59,862	84,000	1992	
F-2/AC-2																
OPEN OFFICE	1522	ARTIFICIAL	MECHANICAL	8	8 × 7.5 = 60 CFM	0	0	MECHANICAL	_		60	ASHRAE	23,060	27,194	624	
CONFERENCE 1	203	ARTIFICIAL	MECHANICAL	11	11 x 7.5 = 83 CFM	0	20.5	MECHANICAL	_	1756	83	T <b>OSAI</b> RAE	16,499	29,106	640	
HALLWAY 1ST	223	ARTIFICIAL	MECHANICAL	_	-	0	20.5	MECHANICAL	-	<b>~~~</b>		ASHRAE	16,001	18,510	609	
RESTROOM 1	43	ARTIFICIAL	MECHANICAL	_	_	1 x 75 = 75 CFM	0	MECHANICAL	EF#1	NOT ALLOWED	_	ASHRAE	1,409	2,298	50	
RESTROOM 2	43	ARTIFICIAL	MECHANICAL	_	_	1 x 75 = 75 CFM	0	MECHANICAL	EF#1	NOT ALLOWED	_	ASHRAE	1,409	2,298	50	

				VENTILA-	TION SCHE	DULE 2ND	FLOOR								
ROOM DESCRI	PTION		C	RDINANCE REQUIRE	MENTS			ACTU	AL PROVIDED			HEATING DATA	(-10° OUTSIDE	/ 70° INSIDE)	
	DOOM ADEA	NATURAL LIG		ESTIMATED MAX. OCCUPANT LOAD, PERSONS PER	CCUPANT LOAD, CUBIC FEET				RETURN AIR FROM ROOM	OUTDOOR AIR SUPPLY	BASSIS OF HEAT LOSS	ORIDNANCE REQUIREMENT	ACTUAL	ACTUAL CFM SUPPL	
ROOM NAME	ROOM AREA (SQ.FT)	GLASS AREA (S.F.) 8% FLOOR AREA		1,000 SQ.FT.	PER PERSON	EXHAUST AIR FROM ROOM	GLASS AREA (SQ.FT.)	VENT AREA (SQ.FT.)	EXHAUST AIR FROM ROOM	FROM ROOM	AIR SUPPLI	CALUCLATION	BTUH HEAT LOSS AT 100%	SUPPLY CFM AT 104°F	AT 104°F
F-3/AC-3												ASHRAE			
CONFERENCE 2	403	ARTIFICIAL	MECHANICAL	21	21 x 7.5 = 158 CFM	0	107.0	MECHANICAL	_	954	158	ASHRAE	31,054	47,339	954
ALLWAY 2ND FLOOR	443	ARTIFICIAL	MECHANICAL	-	-	0	61.0	MECHANICAL	_			ASHRAE	22,933	25,107	506
BREAK ROOM	307	ARTIFICIAL	MECHANICAL	31	31 x 7.5 = 233 CFM	0	0	MECHANICAL	_	630	233	ASHRAE	16,953	18,260	368
KITCHENETTE	111	ARTIFICIAL	MECHANICAL	-	_	О	0	MECHANICAL	_			ASHRAE	5,205	7,294	147
												TOTAL:	76,145	98,000	1975
F-4/AC-4															
DFFICE 1	152	ARTIFICIAL	MECHANICAL	1	1 × 7.5 = 8 CFM	0	29.0	MECHANICAL	_		8	ASHRAE	10,347	10,820	219
OFFICE 2	155	ARTIFICIAL	MECHANICAL	1	1 × 7.5 = 8 CFM	0	0	MECHANICAL	_		8	ASHRAE	8,169	9,130	184
OFFICE 3	152	ARTIFICIAL	MECHANICAL	1	1 × 7.5 = 8 CFM	0	0	MECHANICAL	_		8	ASHRAE	8,035	9,081	183
OFFICE 4	152	ARTIFICIAL	MECHANICAL	1	1 x 7.5 = 8 CFM	0	0	MECHANICAL	_	1708	8	ASHRAE	7,950	8,981	181
FFICE 5	158	ARTIFICIAL	MECHANICAL	1	1 x 7.5 = 8 CFM	0	0	MECHANICAL	_		8	ASHRAE	7,475	9,030	182
FFICE 6	148	ARTIFICIAL	MECHANICAL	1	1 x 7.5 = 8 CFM	0	0	MECHANICAL	-		8	ASHRAE	6,957	8,634	174
FFICE 7	118	ARTIFICIAL	MECHANICAL	1	1 x 7.5 = 8 CFM	0	0	MECHANICAL	_		8	ASHRAE	5,583	7,542	152
FFICE 8	105	ARTIFICIAL	MECHANICAL	1	1 x 7.5 = 8 CFM	0	0	MECHANICAL	_		8	ASHRAE	4,966	7,046	142
ESTROOM 3	53	ARTIFICIAL	MECHANICAL	~~~		1 x 75	0	MECHANICAL	EF#1	NOT ALLOWED		ASHRAE	2,435	4,614	93
					7 × 7.5	+ · · · · · ·		1	· ·	t		t	12,671	23,122	<del>                                     </del>


**REVISIONS:** 

CONSTRUCTION DOCUMENT(S

REVIEWED FOR COMPLIANCE

<u>/1\</u> 01/09/2024


<u>2</u> 02/07/2024

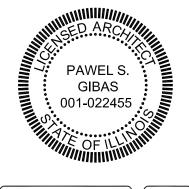

RD 6030 ROOSEVELT PARK

6632 W. OAK

DRAWING TITLE: **MECHANICAL** SCHEDULES, **DETAILS & NOTES** 

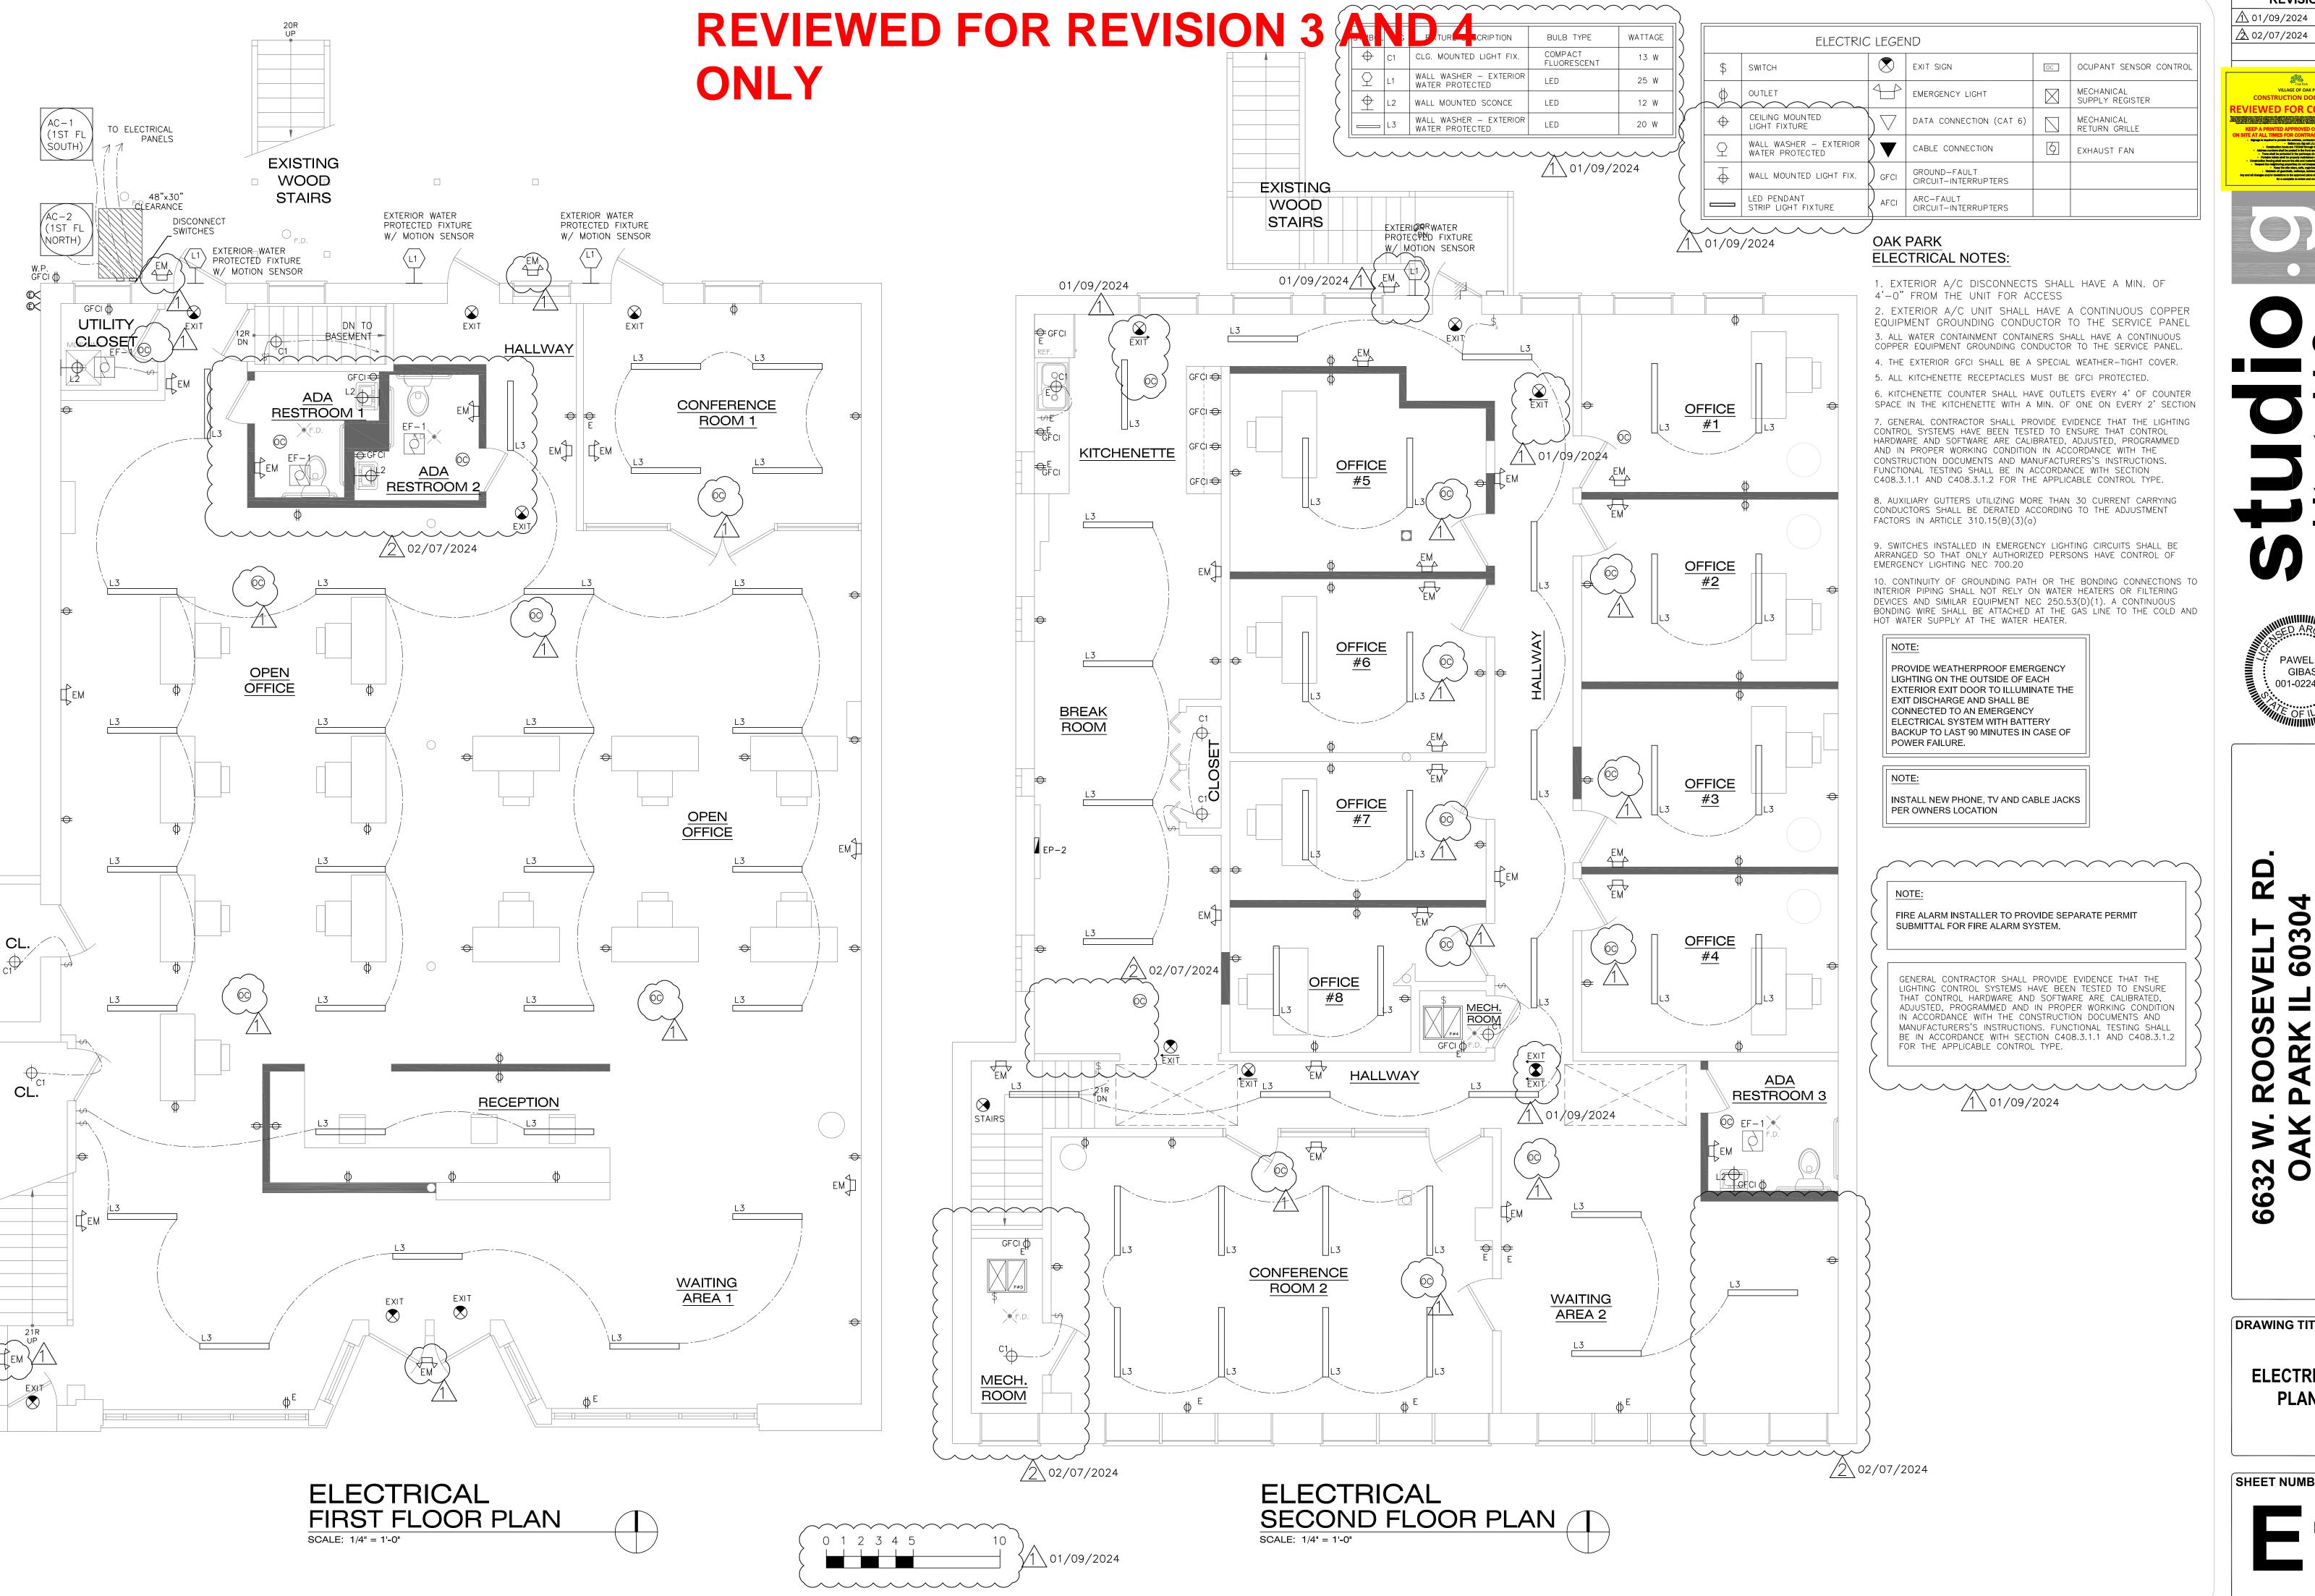

**REVISIONS:** <u>^</u> 02/07/2024

CONSTRUCTION DOCUMENT(S) **EVIEWED FOR COMPLIANC** 

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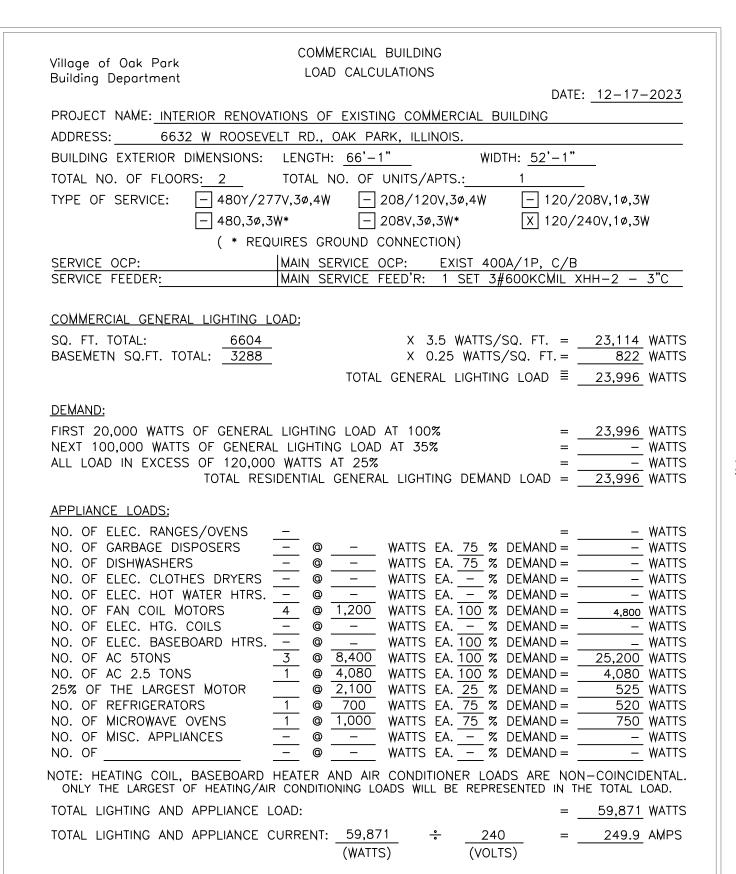
**DRAWING TITLE:** 

**ELECTRICAL PLANS** 

		EXISTING PANEL 1	<u>E</u>	EP-1					
		MTG. SURFACE VOLTAGE				3₩			
		RC. BRKR. 200A/1P LOCATION	B	BASEME	ENT		HEIGHT AS REQUIRED		-
		JGS <u>200A</u> CCTS <u>30</u> FEEDER S	17F 4	1/O A	111 – 3	o"C	WIDTH <u>14"</u> DEPTH 6"		-
		BAR YES SERVED F	_	•			A.I.C. 10,000		-
		DESCRIPTION		, ø ATTS	C Ø KWAT	<b>5</b>	DESCRIPTION	AMF	ССТ
1	20	RECEPT WAITING AREA	1.0	4.2			AC-1 (ON GRADE) C/B	60 /	2
3	20	RECEPT RECEPTION			1.0	4.2	(SEE SINGLE LINE FOR RATING)	$\sqrt{2}$	4
5	20	RECEPTOPEN OFFICE	1.8	2.0		/	AC-2 (ON GRADE) C/B	25/	6
7	20	RECEPTOPEN OFFICE			1.8	2.0	(SEE SINGLE LINE FOR RATING)	/2	8
9	20	RECEPTCONFERENCE ROOM	1.0	0.9			F-1 GAS FURNACE	15	10
11	20	GFI RECEPT RESTROOM 1			1.5	0.9	F-2 GAS FURNACE	15	12
13	20	GFL-REGEPT, UTILITY	1.5	~~			SPACE	-	14
15	20	GFI RECEPT RESTROOM 2			1.5	0.2	SMOKE DETECTORS	15	16
17	20	GFI RECEPT. – EXTERIOR	1.0(	1.0		<u> </u>	EMERGENCY EXIT LIGHTING	15	18
19	_	SPACE			-	)  -	SPACE	Ē	20
21	20	1ST FLOOR LIGHTING	1.0	_			SPACE	<u> </u>	22
23	_	SPACE			_	_	SPACE		24
25	_	SPACE	_	_			SPACE	-	26
27	_	SPACE			_	-	SPACE	<u> </u>	28
29	_	SPACE	_	_		/	SPACE	_	30
		TOTAL KWATTS / PHASE TOTAL KWATTS THIS PANEL	15	28	13.1		≈ 118.8 AMP (CONNECTED)		
									<u></u>
	ı_ı	EXISTING PANEL 2	_	20 /2	10)/ 14	7141			
		MTG. SURFACE VOLTAGE RC. BRKR. 200A/1P LOCATION		20/22 BASEME	40V,1ø,. -Nit	<b>Σ</b> γγ	 HEIGHT AS REQUIRED		
	N LL			AND ENT	_1111		WIDTH 14"		-
		CCTS 30 FEEDER S	IZE 4	1/0 A	LU - 2	2"C	DEPTH 6"		-
CRC	DUNE	) BAR YES SERVED F	ROM N	/ETER	CENTE	R	A.I.C. 10,000		-

02/07/2024

			EXISTING PANEL 2		<u>EP</u>						INSTALL NE   PER OWNE
			MTG. <u>SURFACE</u> VOLTAG RC. BRKR. 200A/1P LOCATI	_		)/24( SEME)	OV,1ø,3₩ NT	 HEIGHT AS REQUIRED			
	MAIN			_	BAS	<u>SCIVICI</u>	<u> </u>	WIDTH 14"		-	
	NO.	OF		R SIZE	4/	O AL	U - 2"C	DEPTH 6"		-	NOTE:
	GRO	UNE	BAR YES SERVE	FRO	√ <u>ME</u>	TER	CENTER	A.I.C. 10,000			BRANCH CI
	ССТ	AMP	DESCRIPTION		A ¢ KWAT		C Ø KWATTS	DESCRIPTION	$\overline{}$	ССТ	CIRCUIT AS LIGHTING F
	1	20	RECEPT WAITING AREA		1.0	4.2		AC-3 (ON ROOF) C/B	60/	2	
	3	20	RECEPT OFFICE 1				1.0 4.2	(SEE SINGLE LINE FOR RATING)	/2	4	
	5	20	RECEPT OFFICE 2		1.8	4.2		AC-4 (ON ROOF) C/B	60/	6	) ^
	7	20	RECEPT. – OFFICE 3				1.8 4.2	(SEE SINGLE LINE FOR RATING)	/2	8	1 01/09/2024
	٩	20	RECEPT - CONFERENCE ROOM		1.0 (	وو		F-3 GAS FURNACE	15	10	
{	11	-	SPACE				- )0.9	F-4 GAS FURNACE	15	12	
	13	20	GFI RECEPT RESTROOM 3		1.5			SPACE	_	14	_
02/07/2024	15	20	RECEPT. – OFFICE 4			$\sqrt{}$	18 0.2	SMOKE DETECTORS	15	16	2 02/07/2024
, ,	17	20	GFI RECEPT ROOF		1.0	1.0		EMERGENCY EXIT LIGHTING	15	18	
	19	20	RECEPT OFFICE 5			$\bigcirc$	1.8 -	SPACE	_	20	
	21	20	2ND FLOOR LIGHTING		1.0 _	-		SPACE	_	22	
	23	20	RECEPT. – OFFICE 6			$\bigcup$	1.8 _	SPACE	-	24	0.0111457
	25	20	RECEPT. – OFFICE 7		1.8 -	-		SPACE	_	26	COMMEF UNI
	27	20	RECEPT OFFICE 8				1.8 –	SPACE	-	28	(FIRST FI
	29	-	SPACE		-	-		SPACE	_	30	
			TOTAL KWATTS THIS BANEL		19.4		19.5	~ 162.0 AMP (CONNECTED)			EXISTING COMMERCIAL CONI
	29	_			19.4	38.9		≈ 162.0 AMP (CONNECTED)	<u>-</u>	30	



# **REVIEWED FOR REVISION 3 AND 4**

SERVICE DROP ---BY COMED

1. EXTERIOR A/C DISCONNECTS SHALL HAVE A MIN. OF 4'-0" FROM THE UNIT FOR ACCESS

2. EXTERIOR A/C UNIT SHALL HAVE A CONTINUOUS COPPER EQUIPMENT GROUNDING CONDUCTOR TO THE SERVICE PANEL 3. ALL WATER CONTAINMENT CONTAINERS SHALL HAVE A CONTINUOUS COPPER EQUIPMENT GROUNDING CONDUCTOR TO THE SERVICE PANEL.

4. THE EXTERIOR GFCI SHALL BE A SPECIAL WEATHER-TIGHT COVER.


5. ALL KITCHENETTE RECEPTACLES MUST BE GFCI PROTECTED. 6. KITCHENETTE COUNTER SHALL HAVE OUTLETS EVERY 4' OF COUNTER SPACE IN THE KITCHENETTE WITH A MIN. OF ONE ON EVERY 2' SECTION

7. GENERAL CONTRACTOR SHALL PROVIDE EVIDENCE THAT THE LIGHTING CONTROL SYSTEMS HAVE BEEN TESTED TO ENSURE THAT CONTROL HARDWARE AND SOFTWARE ARE CALIBRATED, ADJUSTED, PROGRAMMED AND IN PROPER WORKING CONDITION IN ACCORDANCE WITH THE CONSTRUCTION DOCUMENTS AND MANUFACTURERS'S INSTRUCTIONS. FUNCTIONAL TESTING SHALL BE IN ACCORDANCE WITH SECTION C408.3.1.1 AND C408.3.1.2 FOR THE APPLICABLE CONTROL TYPE.

8. AUXILIARY GUTTERS UTILIZING MORE THAN 30 CURRENT CARRYING 72024 CONDUCTORS SHALL BE DERATED ACCORDING TO THE ADJUSTMENT FACTORS IN ARTICLE 310.15(B)(3)(a)

9. SWITCHES INSTALLED IN EMERGENCY LIGHTING CIRCUITS SHALL BE ARRANGED SO THAT ONLY AUTHORIZED PERSONS HAVE CONTROL OF EMERGENCY LIGHTING NEC 700.20

10. CONTINUITY OF GROUNDING PATH OR THE BONDING CONNECTIONS TO INTERIOR PIPING SHALL NOT RELY ON WATER HEATERS OR FILTERING DEVICES AND SIMILAR EQUIPMENT NEC 250.53(D)(1). A CONTINUOUS BONDING WIRE SHALL BE ATTACHED AT THE GAS LINE TO THE COLD AND HOT WATER SUPPLY AT THE WATER HEATER.

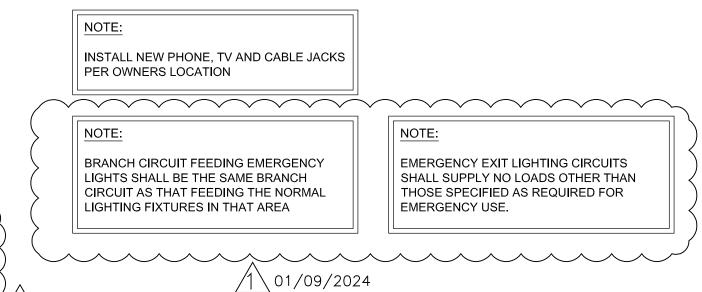


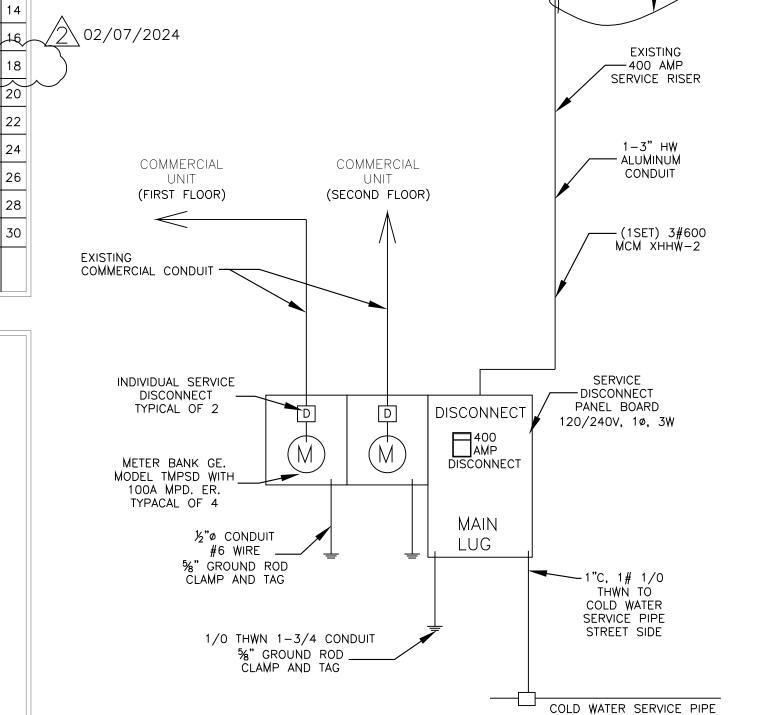


DIAGRAM OF FEEDERS

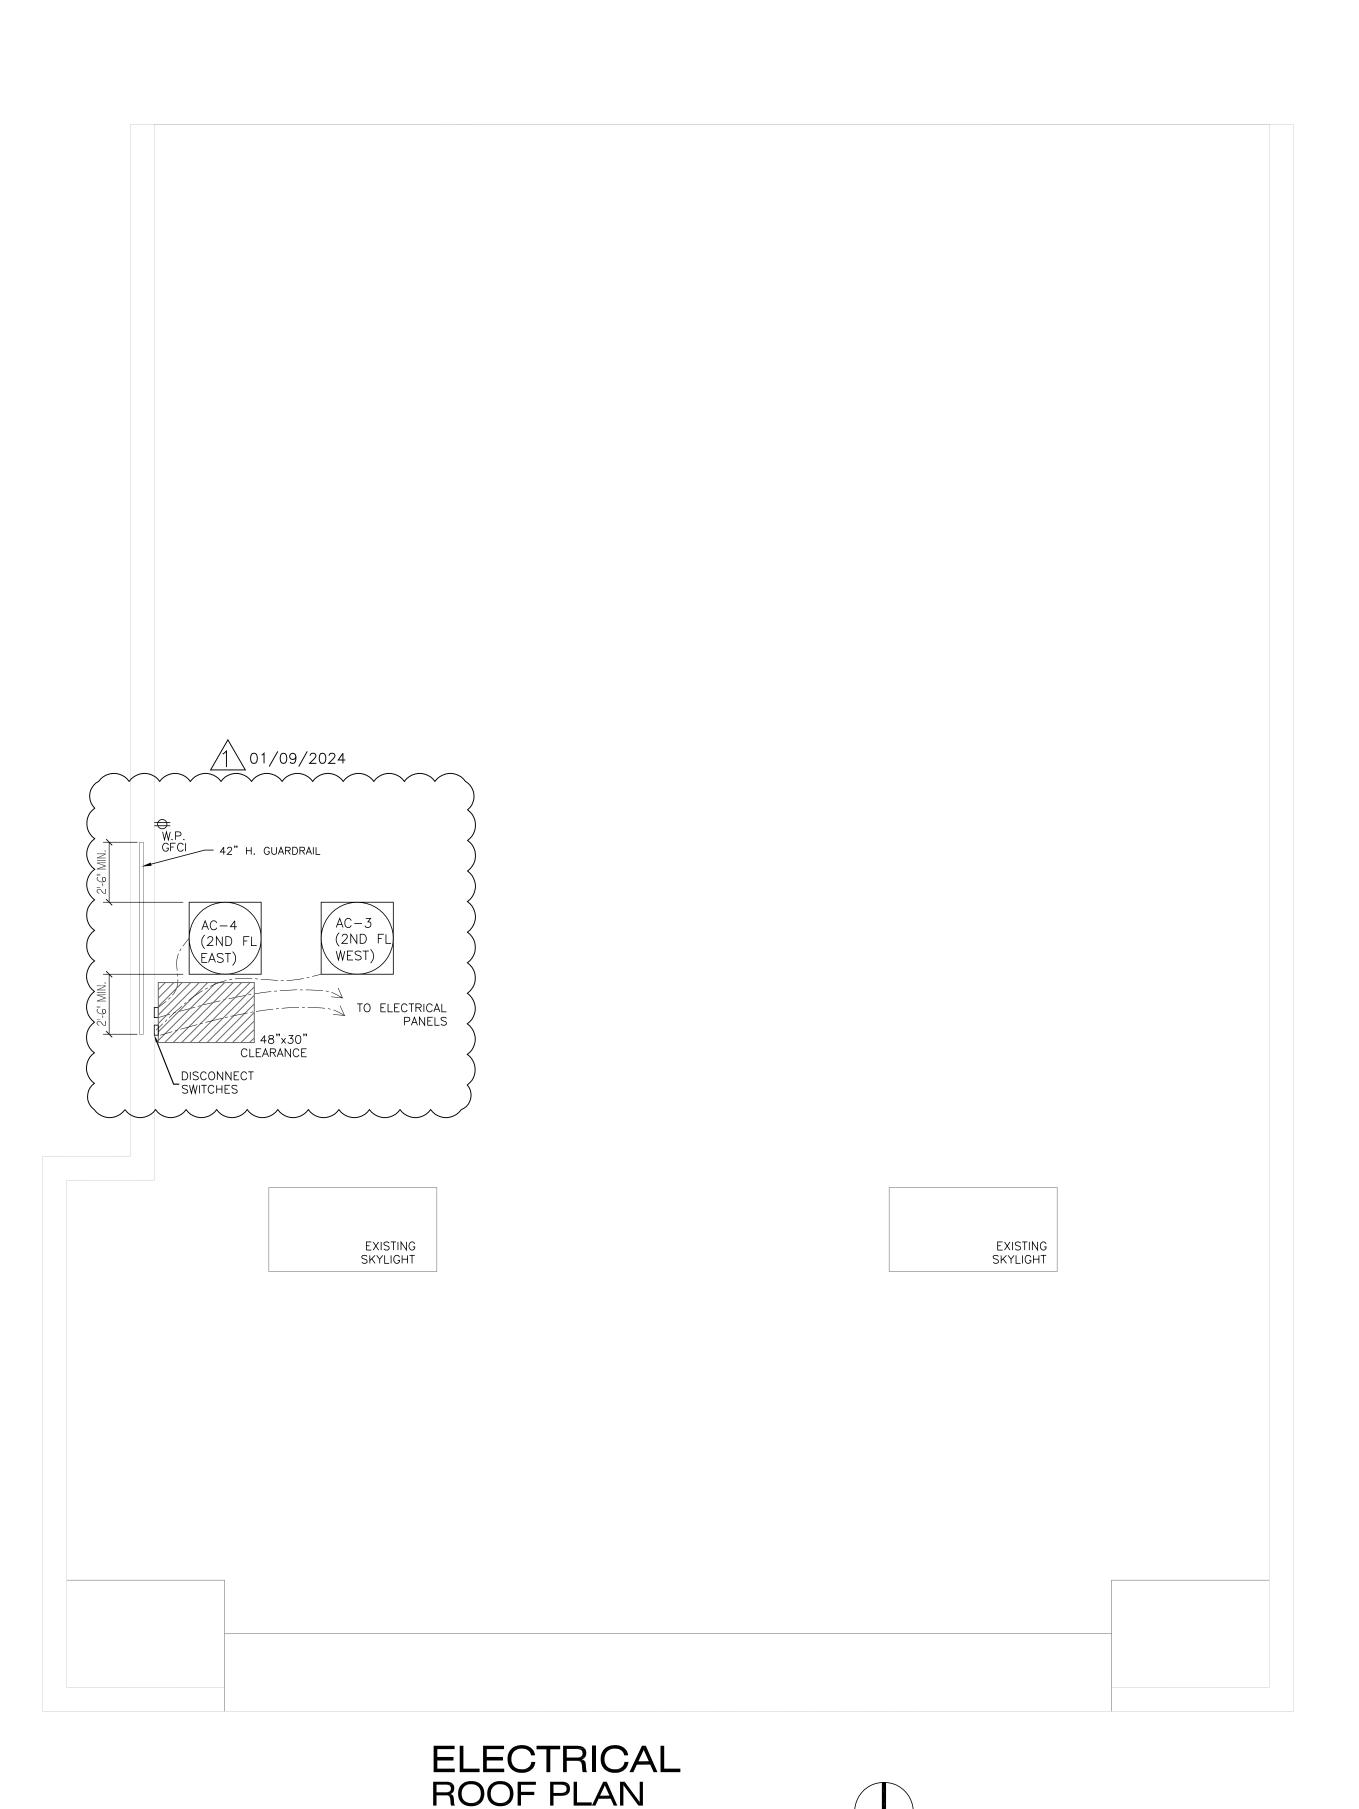

SCALE: 1/4" = 1'-0"

0 1 2 3 4 5

/1\01/09/2024

**REVISIONS:** 1 01/09/2024

1 /2 02/07/2024 CONSTRUCTION DOCUMENT(S) REVIEWED FOR COMPLIANCE





RD

6030

DRAWING TITLE: **ELECTRICAL ROOF PLAN,** 

NOTES &

**SCHEDULES** 


Russell Schomig PLS # 035-002446

### SCHOMIG LAND SURVEYORS, LTD. Plat of Survey

009 East 31st Street LaGrange Park, Illinois 80528 Office (708) 352-1452 Fax (708) 352-1464

LOTS 22 AND 23 IN BLOCK 11 IN SWIGART'S SUBDIVISION OF LOT 5 AND THE WEST 33 FEET OF LOT 6 IN THE SUBDIVISION OF SECTION 18, TOWNSHIP 39 NORTH, RANGE 13, EAST OF THE THIRD PRINCIPAL MERIDIAN, (EXCEPT THE WEST 1/2 OF THE SOUTHWEST 1/4 THEREOF) IN COOK COUNTY, ILLINOIS.

COMMON ADDRESS: 6634 WEST ROOSEVELT ROAD

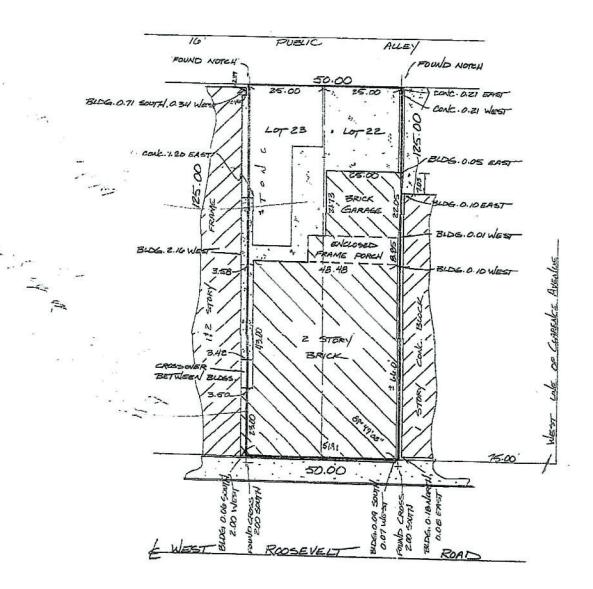

COMPARE LEGAL DESCRIPTION WITH DEED AND REPORT ANY DISCREPANCY IMMEDIATELY. A TITLE COMMITMENT WAS NOT FURNISHED FOR USE IN PREPARATION OF THIS SURVEY. IF A FURNISHED FOR USE IN PREPARATION OF THIS SURVEY. IF A EASEMENTS, BUILDING LINES OR OTHER RESTRICTIONS NOT SHOWN ON THIS PLAT. THIS PLAT DOES NOT SHOW BUILDING RESTRICTIONS ESTABLISHED BY LOCAL COMINANCES. LOCAL AUTHORITIES MUST BE CONSULTED RECARDING ANY NO EXTRAPOLATIONS SHOULD BE MADE FROM THE PLAT. NO EXTRAPOLATIONS SHOULD BE MADE FROM THE MORPHATION SHOWN WITHOUT THE PERMISSION OF SCHOWIG LAND SURVEYORS, LID. THIS PLAT IS NOT TRANSFERBELE, ONLY PRINTS WITH AN EMBOSSED SEAL ARE OFFICIAL COPIES. @COPYRIGHT, ALL RIGHTS RESERVED.

SURVEYED:


NOVEMBER 14, 2002

BUILDING LOCATED: NOVEMBER 14, 2002

ORDERED BY: Fuchs & Roselli, Limited

PLAT NUMBER:89H51

SCALE: 1"= 20"

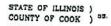

WE SCHOMIG LAND SURVEYORS, LTD. AS ILLINOIS LICENSED PROFESSIONAL LAND SURVEYORS, HEREBY CERTIFY THAT WE HAVE SURVEYED THE PROPERTY DESCRIBED IN THE CAPTION TO THE PLAT HEREON DRAWN AND THAT THE SAID PLAT IS A TRUE AND CORRECT REPRESENTATION OF THE SAME.

ALL DIMENSIONS ARE IN FEET AND DECIMAL PARTS OF A FOOT AND ARE CORRECT AT A TEMPERATURE OF 68 DEGREES FARRENHEIT, DIMENSIONS SHOWN ON BUILDINGS ARE TO THE OUTSIDE OF BUILDINGS.

THIS PROFESSIONAL SERVICE CONFORMS TO THE CURRENT ILLINOIS MINIMUM STANDARDS FOR A BOUNDARY SURVEY.

LP. = IRON PIPE
C.LF. = CHAIN LINK FENCE
W.F. = WOOD FENCE
B.L = BUILDING LINES
P.U.E. = PUBLIC UTILITY EASEMENT
D.E. = DRAINAGE EASEMENT

PROFESSIONAL ILLINOIS LAND SURVEYOR

WHAT E HANTON IS S. HOMEWOOD, IE ONES THAT THE STREET WITH THE

LOT 22 AND 23 IN BLOCK II IN SWIGART'S SUBDIVISION OF LOT 5 AND THE WEST 33 FEET OF LOT 6 IN B.F. JARVIS SUBDIVISION OF SECTION 18, TOWNSHIP 39 NORTH, RANGE 13 (EXCEPT THE WEST 1/2 OF THE SOUTHWEST 1/4 THEREOF), EAST OF THE THIRO PRINCIPAL MERIDIAN, COOK COUNTY, ILLINGIS.


NDTE: BEARING SYSTEM ASSUMED FOR PURPOSE OF THIS SURVEY

N

DERTIFY TO: FIRST AMERICAN TITLE INSURANCE COMPANY



#### 16' PUBLIC ALLEY

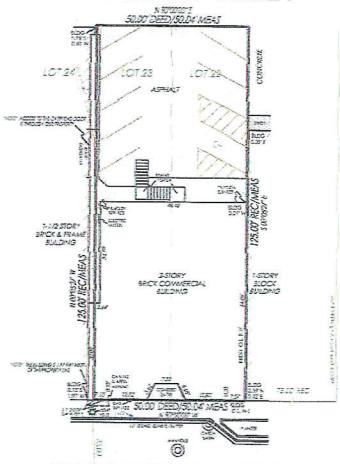

FARKING STALLS S STANDARD SPECIAL NEEDS

> LOT AREA: 5,250,0 SQ. FT. D.14 ACRES

THIS IS TO DERTIFY THAT THIS MAP OR PLAT AND THE SURVEY ON WHICH IT IS BASED WERE MADE IN ACCORDANCE WITH THE ROLS MINIMUM STANDARD DETAIL REDDINGMENTS FOR ALTAINEDS LAND, TITLE SURVEYS, JOINITH STRABLISHED AND ADDITED BY ALTAIND NSPS, AND INCLUDES ITAMS 2, 4, 700, 8, 5, 71 S 14 OF TABLE A THEREOF, THE FIELDWORK WAS DOMPLETED ON DECEMBER 5, 2018.

DATE OF PLAT OR MAN DECEMBER 6, SUITS.

ASTRUMENT

ROOSEVELT

ESCHEET WASSET TOTALE & SAND

D.	50.	40	SI
	AR DESCRIPTION	SHEET STREET	MUSTS

ROAD

THE METALLER AT STREET AND ALT THE STET AND DEPOSITE PARTY THESE OF WILL METALLE DIS TREATMENTS AND TO BE DESCRIBED BY SEALING.

ENLE_	t"=zat.
JEH NEL	12-1772-
ACTORCOM	WELL RELEASEMENT AT.
	DAX BARK IL
FLORE	un the backery
TURNSHIP.	DAE PARE
SHOCKED BY	TIM WINTER






ISLASS MARTIN AVE HOMEN ALP I HAVE TELEVISION TO LONG TO

LOT 22 AND 29 IN BLOCK 11 IN SWIGARTS SUBDIVISION OF LOT 5 AND THE WEST 33 FEET OF LOT 6 IN S.F. JARVIS SUBDIVISION OF SECTION 18. TOWNSHIP 39 NORTH, RANGE 13 (EXCEPT THE WEST 1/2 OF THE SOUTHWEST 1/4 THEREOF). EAST OF THE THIRD PRINCIPAL MERIDIAN. COOK GOUNTY. ILLINDIS.

### PUBLIC ALLEY

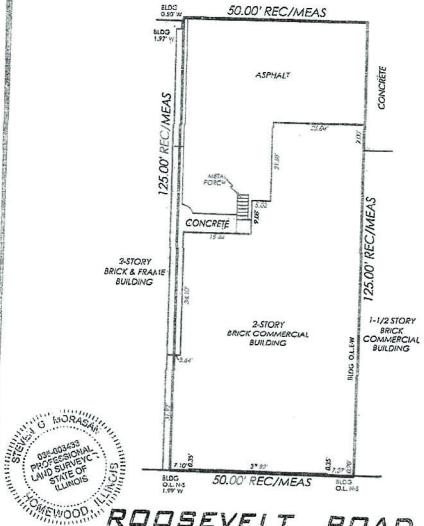

ROOSEVELT ROAD

LAST AREA - 151.L eq. YT AS PER QUENT AGENT, VIGHUMENTS HIGT ACCO. ERED AT THE DET THE BUT ET WARE HET REDET - 40762 THE THE STATE OF THE PROPERTY 904L3 \_\_\_\_\_\_\_ 320 V/X OUT ESS TOZE POUBEVELT TO So 1- FRANCISCO REMARK YOUR ONLOGHERTO', AND SHYDISAL TURSHIES WITH THIS S. T. WASSELLE ... DATESTO LE SE IN FORCE 2 14 1 MANGELE. MERCH שלטו זו מרטיאטנד ליין ביין ביין בארטיאה ביים



